

Note: All illustrations are artist's concept. E.&O.E

PROPOSED RESIDENTIAL DEVELOPMENT 26-38 Hounslow Ave,

North York, ON M2N 2A8

ARCHITECTURAL DRAWING LIST

	OPA/ZBA DRAWING LIST	
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A 6.00	SECTION A	
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A 6.02	SECTION 2	

TEAM DIRECTORY:

AERIAL VIEW

CLIENT:

CIVIL:

WSP

Mattamy Homes Canada 300 Bloor Street West, Suite Toronto ON M8X2X2

100 Commerce Valley Drive Inc.

PLANNER: Bousfields Inc.

t. 416.947.9744

bousfields.ca

WIND:

MEP Design INC Suite 100

1060 Sheppard Ave. West, Toronto ON M3J 0G7 t. 416.781.9205 mepdesign.com

LANDSCAPE ARCHITECT:

ENERGY:

Gradient Wind Engineering L4K 4R1 t. 647.932.4054

EQ Building Performance Inc. 20 Floral Pkwy, Concord, ON

Trace Engineering LTD. 100 Allstate Parkway, Suite Markham ON L3R 6H3

t. 416.391.2633

trace-engineering.com

ELECTRICAL:

MECHANICAL:

Trace Engineering LTD.

Markham ON L3R 6H3

trace-engineering.com

t. 416.391.2633

100 Allstate Parkway, Suite

STRUCTURAL:

Thornhill ON L3T 0A1

t. 289.982.4338

wsp.com

Salas O'Brien 2235 Sheppard Ave E. #1100 100 Commerce Valley Drive North York, ON M2J 5B4 t. 416.635.9970 salasobrien.com

127 Walgreen Road

Carp, ON KOA 1LO

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West

TRANSPORTATION:

Thornhill ON L3T 0A1

KEMPFORT BLVD HOUNSLOW AVE HORSHAM AVE HORSHAM AVE CONTEXT PLAN

Scale: 1:2000

ISSUED FOR OPA/ZBA SUBMISSION, SEPTEMBER 29, 2023

Issued:

General Notes:

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interpretations of these documents by the Contractor. Upon written application the Architect will provide written/graphic clarification or supplementary information regarding the intent of the Contract Documents. The Architect will review Shop Drawings submitted by the Contractor for

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3. Positions of exposed or finished

items not clearly located will be located as directed by the Architect

discrepancies with the Contract Documents to the Architect before commencing work.

mechanical or electrical devices, fittings, and fixtures are indicated on the Architectural drawings. The locations shown on the Architectural drawings govern over the Mechanical and Electrical drawings. Those

STUDIOJCI

Architect:

20 De Boers Drive suite 525 Toronto, ON M3J 0H1 t. 416.901.6528 www.studiojci.com



TRUE NORTH



PROPOSED RESIDENTIAL DEVELOPMENT

26-38 Hounslow Ave, North York, ON M2N 2A8

COVER

Project No.: 2224 Date: SEPTEMBER 29, 2023
Drawn by: STUDIO JCI

Drawing No.:

A 0.00

PROPOSED RESIDENTIAL DEVELOPMENT

26-38 Hounslow Road, North York, ON M2N 2A8

01. SITE AREA	(m²)
Lot area	2159.8 m ²

02. GROSS FLOOR AREA	(m²)
Total GCA	25060.7 m ²
GFA exclusions (By-Law 569-2013)***	6324.3 m ²
Total GFA	18736.5 m²

03. F.S.I.**	PROPOSED
	8.68

04. LOT COVERAGE	(%)
	77.96%

05. RESIDENTIAL UNITS	PROPOSED
Unit type	Count
1 Bedroom	117
1 Bedroom + Den	87
2 Bedroom	71
3 Bedroom	30
TOTAL	305

06. CAR PARK	PROPOSED	
(refer to Transportation		
Standard Parking		71
Accessible Parking	9	
		80

07. BIKE PARKING	PROPOSED
(refer to Transportation Report)	
Residential (long term)	230
Visitor (short term)	34
TOTAL	264

08. AM	PROPOSED	
Indoor		610.8 m ²
Outdoor		738.7 m²
	TOTAL	1349.5 m²

PROPOSED

As per By-Law 7-16	184.35m
10. BUILDING HEIGHT	PROPOSED
Without MPH	73.95 m
With MPH	79.75 m

09. ESTABLISHED GRADE*

*BUILDING HEIGHT DETERMINED AS FOLLOWS:

THE HEIGHT OF A BUILDING IS THE DISTANCE BETWEEN THE ESTABLISHED GRADE AND THE ELEVATION OF THE HIGHEST POINT OF THE BUILDING (ZONING BY-LAW 569-2013).

ESTABLISHED GRADE IS CALCULATED AS AVERAGE ELEVATION OF THE GROUND ALONG ALL LOT LINES THAT ABUT A STREET (HOUNSLOW) AT PROPERTY LINE.

AVERAGE OF 184.15 and 184.55 = 184.35

**GROSS CONSTRUCTION AREA:

*ALL RESIDENTIAL PARKING SPACES TO BE

EQUIPPED WITH AN ENERGIZED OUTLET CAPABLE OF PROVIDING LEVEL 2 CHARGING

**25% OF NON-RESIDENTIAL PARKING

SPACES TO BE EQUIPED WITH AN ENERGIZED

80

OUTLET CAPABLE OF PROVIDING LEVEL 2

OR HIGHER.

CHARGING OR HIGHER.

MEANS THE AREA MEASURED TO THE OUTSIDE SURFACE OF EXTERIOR WALLS FOR EACH FLOOR WITHOUT DEDUCTION. THIS INCLUDES ENCLOSED STRUCTURED PARKING BUT EXCLUDES THE ROOF LEVEL OF A STRUCTURE (WHETHER PARKING STRUCTURE OR ROOF OF BUILDING)

***GROSS FLOOR AREA: City of Toronto Zoning By-Law 569-2013 10.5.40.40. Floor Area Section 4

(4) Gross Floor Area Calculations for an Apartment Building: In the Residential Zone category, the gross floor area of an apartment building is reduced by the area in the building

(A) parking, loading and bicycle parking below established grade; (B) required loading spaces and required bicycle parking spaces at or above established grade; (C) storage rooms, washrooms, electrical, utility, mechanical and ventilation rooms in the basement; (D) shower and change facilities required by this By-law for required bicycle parking spaces; (E) indoor amenity space required by this By-law;

(F) elevator shafts; (G) garbage shafts; (H) mechanical penthouse; and (I) exit stairwells in the building.

UNIT SUMMARY

RESIDENTIAL UNIT COUNT										
Level	1B	1B+D	2B	3B	Count					
GROUND FLOOR	0	3	0	1	4					
2 FLOOR	0	0	4	1	5					
3 FLOOR	3	4	8	3	18					
4 FLOOR	3	4	8	3	18					
5 FLOOR	3	4	8	3	18					
6 FLOOR	6	6	1	1	14					
7 FLOOR	7	5	1	1	14					
8 FLOOR	7	5	1	1	14					
9 FLOOR	7	5	1	1	14					
10 FLOOR	7	5	1	1	14					
11 FLOOR	7	5	1	1	14					
12 FLOOR	7	5	1	1	14					
13 FLOOR	5	3	3	1	12					
14 FLOOR	5	3	3	1	12					
15 FLOOR	5	3	3	1	12					
16 FLOOR	5	3	3	1	12					
17 FLOOR	5	3	3	1	12					
18 FLOOR	5	3	3	1	12					
19 FLOOR	5	3	3	1	12					
20 FLOOR	5	3	3	1	12					
21 FLOOR	5	3	3	1	12					
22 FLOOR	5	3	3	1	12					
23 FLOOR	5	3	3	1	12					
24 FLOOR	5	3	3	1	12					
TOTAL	117	87	71	30	305					

UNIT Count Name | Count | Percent | Total Unit Area | Average Unit Size

117 | 38.4% | 53,808.8 ft² 459.9 ft² 87 | 28.5% | 47,940.3 ft² 551.0 ft² 680.9 ft² 71 | 23.3% | 48,346.9 ft² 30 9.8% 27,111.9 ft² 903.7 ft²

581.0 ft² TOTAL 305 100.0% 177,207.8 ft²

ADEA CLINANAADV

<u>AREA SUMM</u>	<u>IARY</u>																	
GROSS CONSTRUCTION BUILDING AREA (GCA)**		AREA (GCA)**	RESIDENTIAL (UNIT AREA)		RESIDENTIAL STORAGE		VEHICLE PARKING		COMMON AREA / CIRCULATION		INDOOR AMENITY		OUTDOOR AMENITY		GFA EXEMPTIONS *** (PER BYLAW 569-2013)		TOTAL GFA	
LEVEL	m2	SF	m2	SF	m2	SF	m2	sf	m2	sf	m2	sf	m2	sf	m2	sf	m2	sf
P2 LEVEL	2025.3 m ²	21,800.7 ft ²	0.0 m ²	0.0 ft ²	0.0 m ²	0.0 ft ²	1752.3 m²	18,861.8 ft ²	273.0 m ²	2,938.9 ft ²	0.0 m ²	0.0 ft ²	0.0 m²	0.0 ft ²	1996.0 m²	21,484.5 ft ²	29.4 m²	316.2 ft ²
P1 LEVEL	2025.3 m ²	21,800.7 ft ²	0.0 m ²	0.0 ft ²	0.0 m ²	0.0 ft ²	1681.3 m²	18,097.8 ft ²	344.0 m ²	3,702.9 ft ²	0.0 m ²	0.0 ft ²	0.0 m²	0.0 ft ²	1996.0 m²	21,484.5 ft ²	29.4 m²	316.2 ft ²
GROUND FLOOR	1209.8 m²	13,022.4 ft ²	240.0 m ²	2,583.1 ft ²	0.0 m ²	0.0 ft ²	132.9 m²	1,430.4 ft ²	609.2 m ²	6,556.9 ft ²	227.8 m ²	2,452.1 ft ²	231.2 m²	2,489.0 ft ²	556.4 m²	5,989.3 ft ²	653.4 m²	7,033.1 ft ²
2 FLOOR	822.1 m ²	8,849.0 ft ²	342.5 m ²	3,686.4 ft ²	0.0 m ²	0.0 ft ²	0.0 m²	0.0 ft ²	307.8 m ²	3,312.9 ft ²	171.8 m²	1,849.6 ft ²	237.3 m²	2,554.5 ft ²	373.6 m²	4,021.6 ft ²	448.5 m²	4,827.3 ft ²
3 FLOOR	1293.1 m²	13,918.4 ft²	1086.4 m²	11,694.4 ft²	13.8 m²	148.1 ft²	0.0 m²	0.0 ft ²	192.9 m²	2,075.9 ft ²	0.0 m ²	0.0 ft ²	105.4 m²	1,134.5 ft ²	62.9 m²	677.1 ft ²	1230.2 m²	13,241.3 ft ²
4 FLOOR	1293.1 m²	13,918.4 ft ²	1086.4 m²	11,694.4 ft ²	32.1 m ²	345.1 ft ²	0.0 m²	0.0 ft ²	174.6 m²	1,878.9 ft ²	0.0 m ²	0.0 ft ²	0.0 m²	0.0 ft ²	62.9 m²	677.1 ft²	1230.2 m²	13,241.3 ft ²
5 FLOOR	1293.1 m²	13,918.4 ft ²	1086.4 m²	11,694.4 ft ²	32.1 m ²	345.1 ft ²	0.0 m²	0.0 ft ²	174.6 m²	1,878.9 ft ²	0.0 m ²	0.0 ft ²	0.0 m²	0.0 ft ²	62.9 m²	677.1 ft ²	1230.2 m ²	13,241.3 ft ²
6 FLOOR	829.9 m²	8,933.1 ft ²	714.9 m²	7,695.0 ft ²	0.0 m ²	0.0 ft ²	0.0 m²	0.0 ft ²	115.0 m²	1,238.1 ft ²	0.0 m ²	0.0 ft ²	0.0 m²	0.0 ft ²	46.2 m²	497.1 ft ²	783.7 m²	8,436.0 ft ²
7 FLOOR	811.9 m²	8,739.4 ft ²	696.9 m²	7,501.4 ft ²	0.0 m ²	0.0 ft ²	0.0 m²	0.0 ft ²	115.0 m ²	1,238.0 ft ²	0.0 m ²	0.0 ft ²	0.0 m²	0.0 ft ²	46.2 m²	497.1 ft ²	765.7 m²	8,242.3 ft ²
8 FLOOR	811.9 m²	8,739.4 ft ²	696.9 m²	7,501.3 ft ²	0.0 m ²	0.0 ft ²	0.0 m²	0.0 ft ²	115.0 m²	1,238.0 ft ²	0.0 m ²	0.0 ft ²	0.0 m²	0.0 ft ²	46.2 m²	497.1 ft ²	765.7 m²	8,242.3 ft ²
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13 FLOOR	748.1 m²	8,052.1 ft ²	643.8 m ²	6,929.3 ft ²	0.0 m ²	0.0 ft ²	0.0 m²	0.0 ft ²	104.3 m ²	1,122.8 ft ²	0.0 m ²	0.0 ft ²	0.0 m ²	0.0 ft ²	39.7 m²	427.0 ft ²	708.4 m²	7,625.2 ft ²
14 FLOOR	748.1 m²	8,052.1 ft ²	643.8 m ²	6,929.3 ft ²	0.0 m ²	0.0 ft ²	0.0 m²	0.0 ft ²	104.3 m ²	1,122.8 ft ²	0.0 m ²	0.0 ft ²	0.0 m ²	0.0 ft ²	39.7 m²	427.0 ft ²	708.4 m ²	7,625.2 ft ²
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18 FLOOR	748.1 m²	8,052.1 ft ²	643.8 m ²	6,929.3 ft ²	0.0 m ²	0.0 ft ²	0.0 m²	0.0 ft ²	104.3 m ²	1,122.8 ft ²	0.0 m ²	0.0 ft ²	0.0 m ²	0.0 ft ²	39.7 m²	427.0 ft ²	708.4 m²	7,625.2 ft ²
19 FLOOR	748.1 m²	8,052.1 ft ²	643.8 m ²	6,929.3 ft ²	0.0 m ²	0.0 ft ²	0.0 m²	0.0 ft ²	104.3 m²	1,122.8 ft ²	0.0 m ²	0.0 ft ²	0.0 m²	0.0 ft ²	39.7 m²	427.0 ft ²	708.4 m²	7,625.2 ft ²
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MECH	420.7 m ²	4,528.9 ft ²	0.0 m ²	0.0 ft ²	0.0 m ²	0.0 ft ²	0.0 m ²	0.0 ft ²	209.6 m²	2,256.1 ft ²	211.1 m ²	2,272.7 ft ²	164.7 m²	1,773.1 ft ²	414.3 m²	4,459.1 ft ²	6.5 m ²	69.8 ft ²
TOTAL	25060.7 m ²	269,751.6 ft ²	16463.1 m ²	177,207.8 ft ²	77.9 m²	838.2 ft ²	3566.5 m ²	38,390.0 ft ²	4342.4 m ²	46,741.1 ft ²	610.8 m ²	6,574.4 ft ²	738.7 m ²	7,951.1 ft ²	6324.3 m ²	68,073.7 ft ²	18736.5 m ²	201,677.8 ft ²

20589.3 m² 221,621.4 ft² **ABOVE GROUND** GCA^1 2 - Excludes exterior Balcony, Terraces and Driveway at grade. 3 - Includes Loading Bay, Staging area, 1 - Excludes P1, P2 and

Mechanical Penthouse enclosed Parking Ramp.

AMENITY AREA

AMENITY REQUIREMENT SUMMARY		
UNIT COUNT		
305	TOTAL AMENITYI: 4.0m2/unit INDOOR AMENITY: 2.0m2/unit OUTDOOR AMENITY: 40m2 adjoining indoor amenity	

PROPOSED AMENITY SPACE (By-Law 1353-2015) **			
Name	Minimum Amenity Space Required (m2)	Total Proposed (m2)	
INDOOR AMENITY	610	610.8 m²	
OUTDOOR AMENITY	610	738.7 m²	
1349.5 m²			

LOADING AND WASTE

LOADING AREA REQUIREMENTS						
UNIT COUNT						
LOADING SPACE REQUIREMENT	(31-399 DWELLING UNITS	• 1 (ONE) TYPE 'G' LOADING SPACE (LENGTH: 13.0M, WIDTH: 4.0M, HEIGHT: 6.1M)			1)	
STAGING AREA	5.0 m ² FOR THE FIRST 50 UNITS 5.0 m ² FOR EVERY 50 UNITS ABOVE 50	•	PROVIDED:	36.35 m²	(30.50 m	n² Required)
WASTE STORAGE ROOM	25.0 m ² FOR THE FIRST 50 UNITS, 0.26 m ² FOR EVERY UNIT ABOVE 50	•	PROVIDED:	121.43 m²	•	n² Required orage Room)
HOUSEHOLD WASTE RM	1m ² FOR EVERY 100 UNITS				(3.05 Household	Required d Waste Rm)
BULK WASTE	10m²	•	PROVIDED:	10 m²	(10 m²	Required)

VEHICULAR PARKING

VEHICULAR PARKING STATISTICS					
Use	PROPOSED RATE	PROPOSED COUNT			
CAR SHARE	-	1			
RESIDENTIAL	0.20	62			
RESIDENTIAL VISITOR	2+ 0.05/unit	17			
ΓΟΤΑL	-	80			

PROPOSED VEHICLE PARKING DISTRIBUTION			
LEVEL	ТҮРЕ	COUNT	
P1 LEVEL	Accessible Parking	4	
P2 LEVEL	Accessible Parking	5	
ccessible Parking		9	
P1 LEVEL	Standard Parking	32	
P2 LEVEL	Standard Parking	39	
tandard Parking		71	

BICYCLE PARKING

TOTAL VEHICULAR PARKING

*PROPOSED TOTAL COUNT BELOW INCLUDES 10 PUBLICLY ACCESSIBLE SHORT TERM PARKING SPACES ON SITE OR WITHIN PUBLIC BOULEVARD AS SUBJECT SITE IS WITHIN 500m OF TRANSIT STATION

BIKE PARKING STATISTICS					
PARKING TYPE	UNIT COUNT	PARKING RATE	REQUIRED SPACES	PROPOSED SPACES	
ONG TERM	305	0.68	208	230	
SHORT TERM	305	0.07	22	34*	
OTAL		,	'	264	

BICYCLE PARKING WITH ENERGIZED OUTLETS				
LONG TERM	230	15%	35	36

*A MINIMUM OF 15% OF ALL LONG TERM BIKE PARKING SPACES MUST HAVE ENERGIZED OUTLETS

PROPOSED RESIDENTIAL DEVELOPMENT

Issued:

OPA/ZBA

design conformance only.

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General Notes:

Sep. 29, 2023

26-38 Hounslow Ave, North York, ON M2N 2A8

PROJECT STATISTICS

Project No.: 2224 SEPTEMBER 29, 2023 Drawn by: STUDIO JCI

Drawing No.:



Statistics Template - Toronto Green Standard Version 4.0

Mid to High Rise Residential and
all New Non-Residential Development

The Toronto Green Standard Version 4.0 Statistics Template is submitted with Site Plan Control Applications and stand-alone Zoning Bylaw Amendment applications. Complete the table and copy it directly onto the Site Plan submitted as part of the application.

For Zoning Bylaw Amendment applications: complete General Project Description and Section 1. For Site Plan Control applications: complete General Project Description, Section 1 and Section 2. For further information, please visit www.toronto.ca/greendevelopment

General Project Description	Proposed
Total Gross Floor Area	18736.5m2
Breakdown of project components (m²):	
Residential	18736.5m2
Retail	n/a
Commercial	n/a
Industrial	n/a
Institutional/Other	n/a
Total number of residential units	305

Section 1: For Stand Alone Zoning Bylaw Amendment Applications and Site Plan Control Applications

Low Emissions Transportation	Required	Proposed	Proposed %
Number of Parking Spaces		80	
Number of EV Parking Spaces (Residential)		62	
Number of EV Parking Spaces (non-residential)		4	

Cycling Infrastructure	Required	Proposed	Proposed %
Number of long-term bicycle parking spaces (all-uses)		230	ĺ
Number of long-term bicycle parking located on:			
a) first storey of building		n/a	
b) second storey of building		112	
c) first level below-ground		n/a	
d) second level below-ground		118	
e) other levels below-ground		n/a	





TORONTO

Statistics Template – Toronto Green Standard Version 4.0

Mid to High Rise Residential and all New Non-Residential Development

559.2

Kedoned	rioposeu	Proposed 78
	34	
Required	Proposed	Proposed %
Required 392.6	Proposed 559.2	Proposed %
	Reguled	34

Section 2: For Site Plan Control Applications

Soil Volume provided within the public boulevard (m3)

Cycling Infrastructure	Required	Proposed	Proposed %
Number of short-term bicycle parking spaces (all uses) at-grade or on first level below grade		NOT	
Number of publicly accessible bicycle parking spaces		REQUIRED	
Number of energized outlets for electric bicycles		FOR ZBA	

Tree Canopy	Required	Proposed	Proposed %
Total site area (m²)			
Total Soil Volume (40% of the site area ÷ 66 m² x 30 m³)		NOT	
Total number of trees planted		REQUIRED FOR ZBA	Ī
Number of surface parking spaces (if applicable)	1	TONZBA	
Number of shade trees located in surface parking area			

Landscaping & Biodiversity	Required	Proposed	Proposed %
Total non-roof hardscape area (m²)			
Total non-roof hardscape area treated for Urban Heat Island (minimum residential 75% or non-residential 50%) (m²)		NOT	
Area of non-roof hardscape treated with: (indicate m²)		REQUIRED	
a) high-albedo surface material		FOR ZBA	
b) open-grid pavement			
c) shade from tree canopy			

Page 2 of 3



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PROPOSED RESIDENTIAL DEVELOPMENT

ADDRESS: 26-38 Hounslow Ave, North York, ON M2N 2A8

PROJECT STATISTICS

TGS

Project No.: 2224
Scale:
Date: SEPTEMBER 29, 2023
Drawn by: STUDIO JCI


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Statistics Template - Toronto Green Standard Version 4.0
Mid to High Rise Residential and
all New Non-Residential Development

Landscaping & Biodiversity	Required	Proposed	Proposed %
d) shade from high-albedo structures			
e) shade from energy generation structures			
Percentage of Lot Area as Soft Landscaping (non-residential only)		NOT	
Total number of plants		REQUIRED	
Total number of native plants and % of total plants		FOR ZBA	
Available Roof Space (m²)			
Available Roof Space provided as Green Roof (m²)			
Available Roof Space provided as Cool Roof (m²)			
Available Roof Space provided as Solar Panels (m²)			

Bird Collision Deferrence	Required	Proposed	Proposed %
Total area of glazing of all elevations within 16m above grade			
Total area of treated glazing (minimum 85% of total area of glazing within 16m above grade) (m²)		NOT	
Percentage of glazing within 16m above grade treated with:		REQUIRED	
a) Visual markers		FOR ZBA	
b) non-reflective glass			
c) Building integrated structures			



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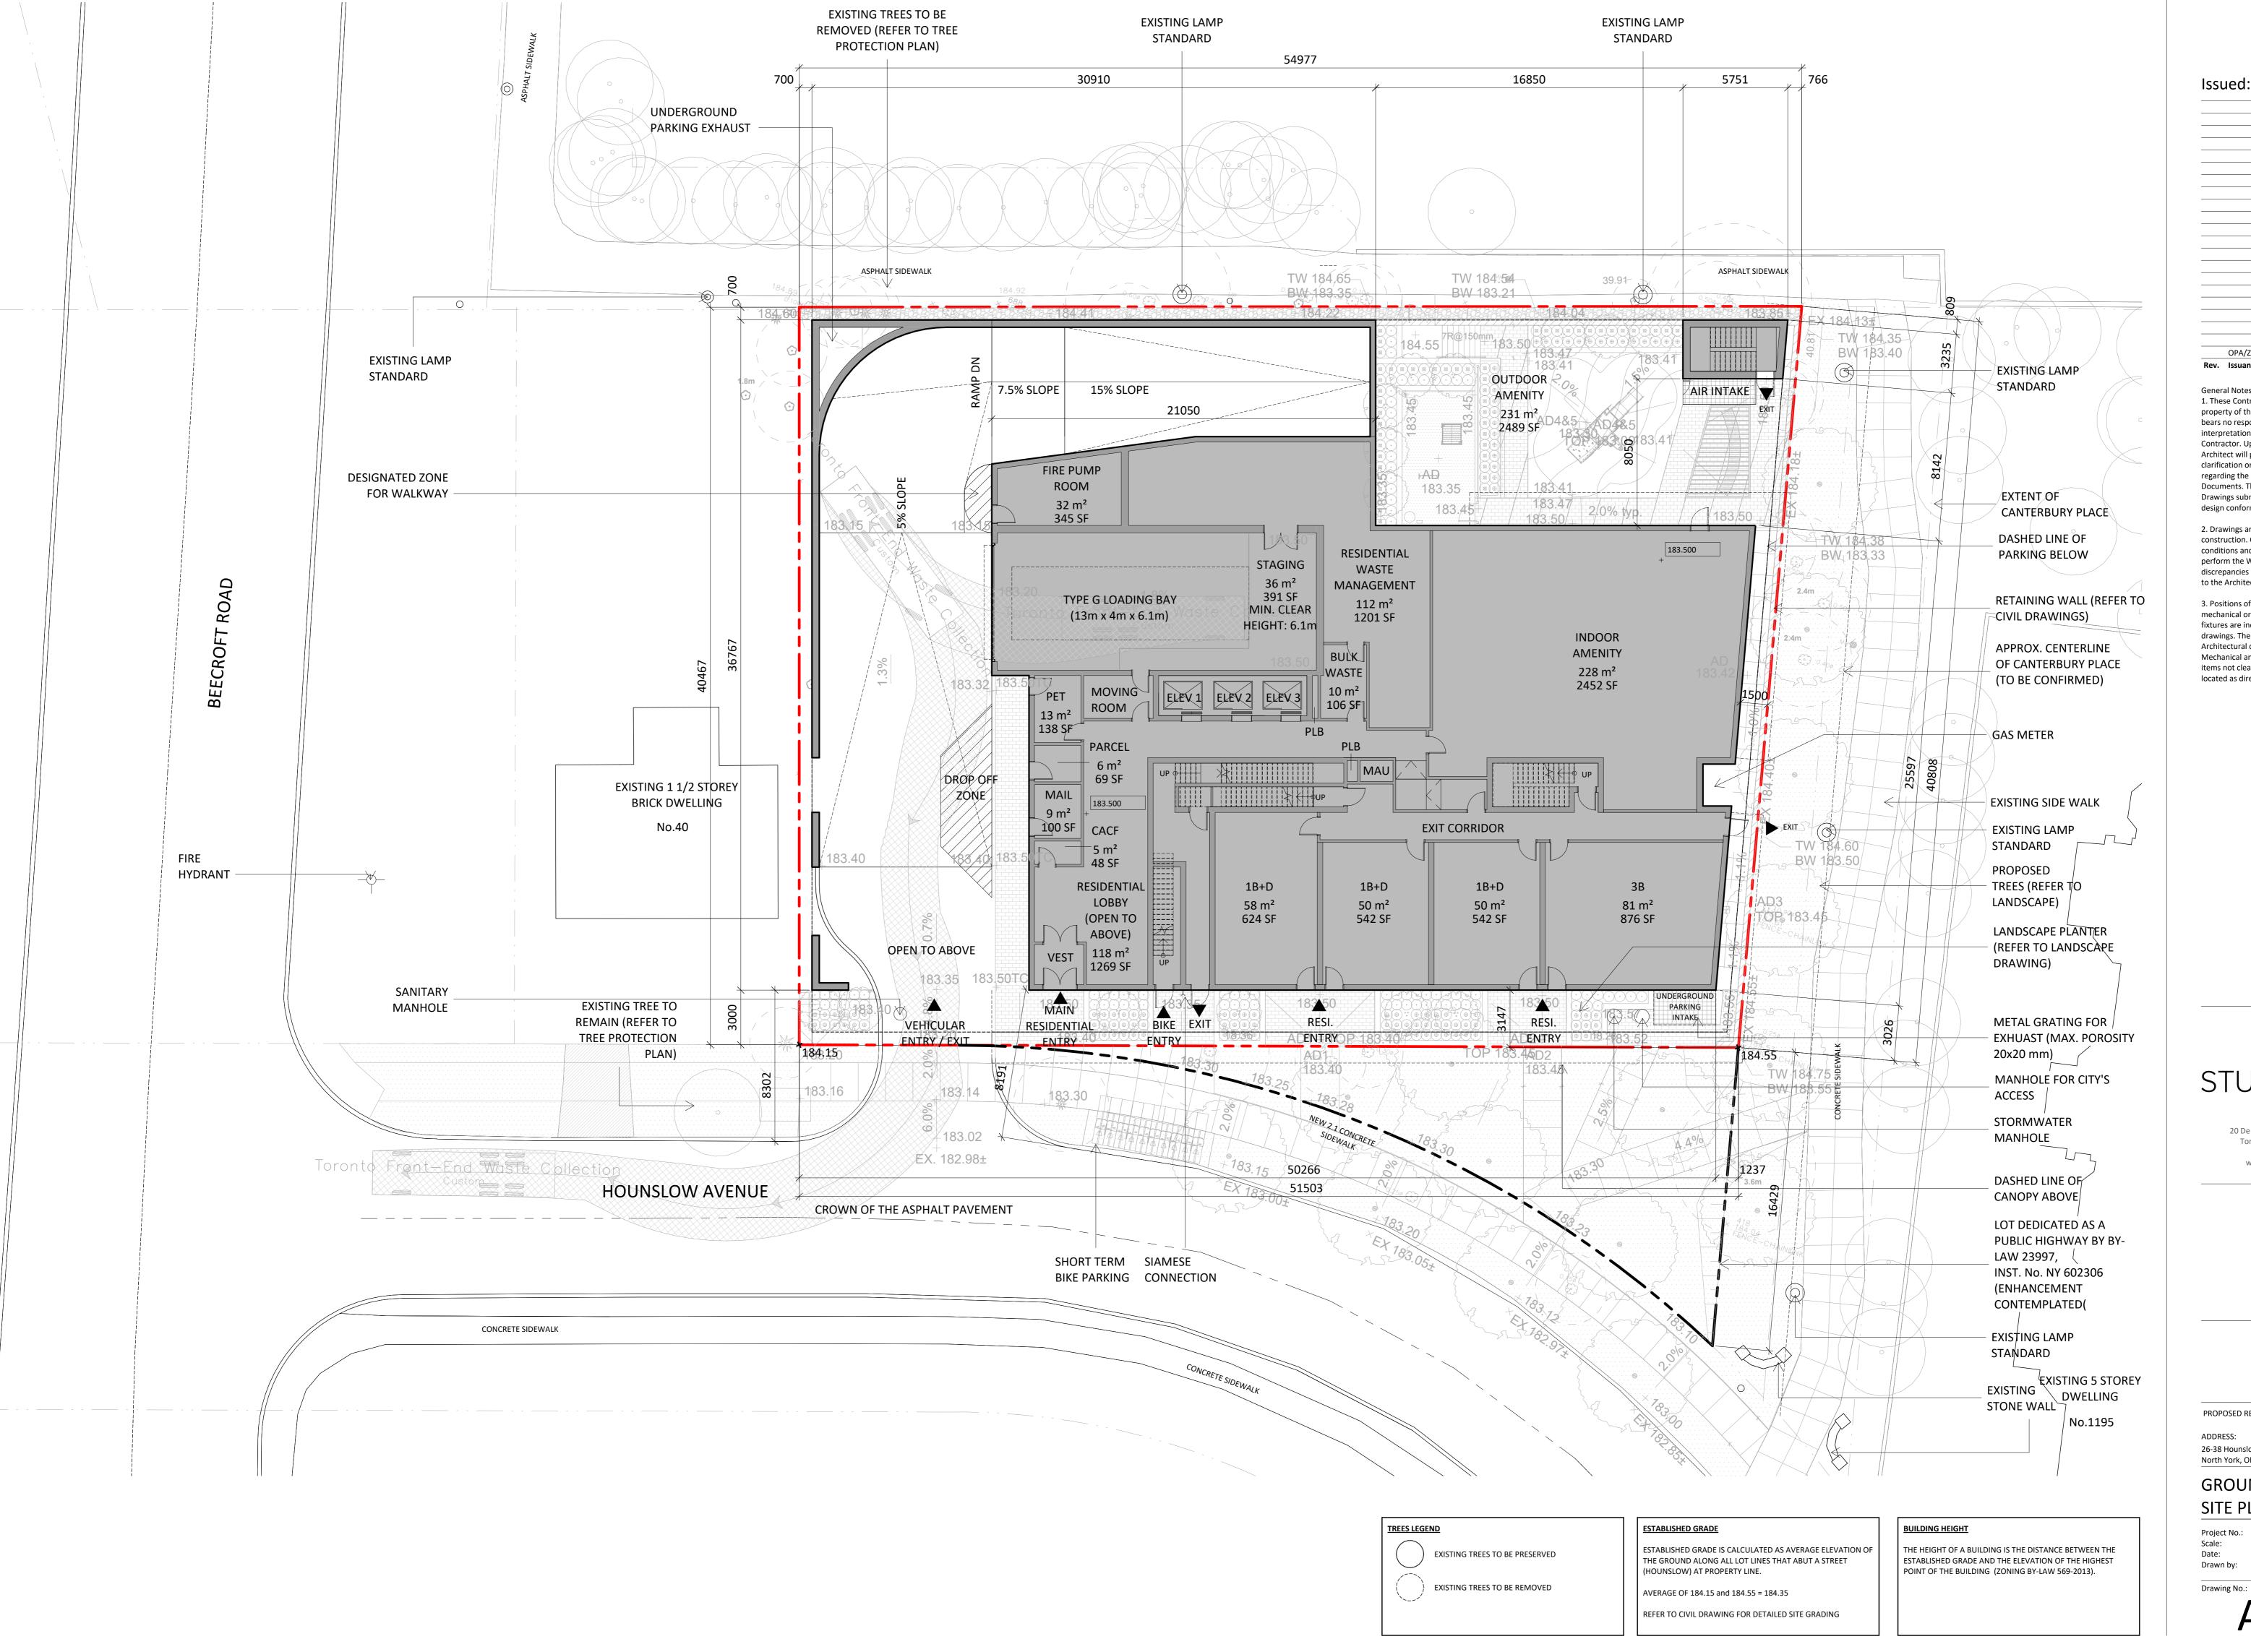
PROPOSED RESIDENTIAL DEVELOPMENT

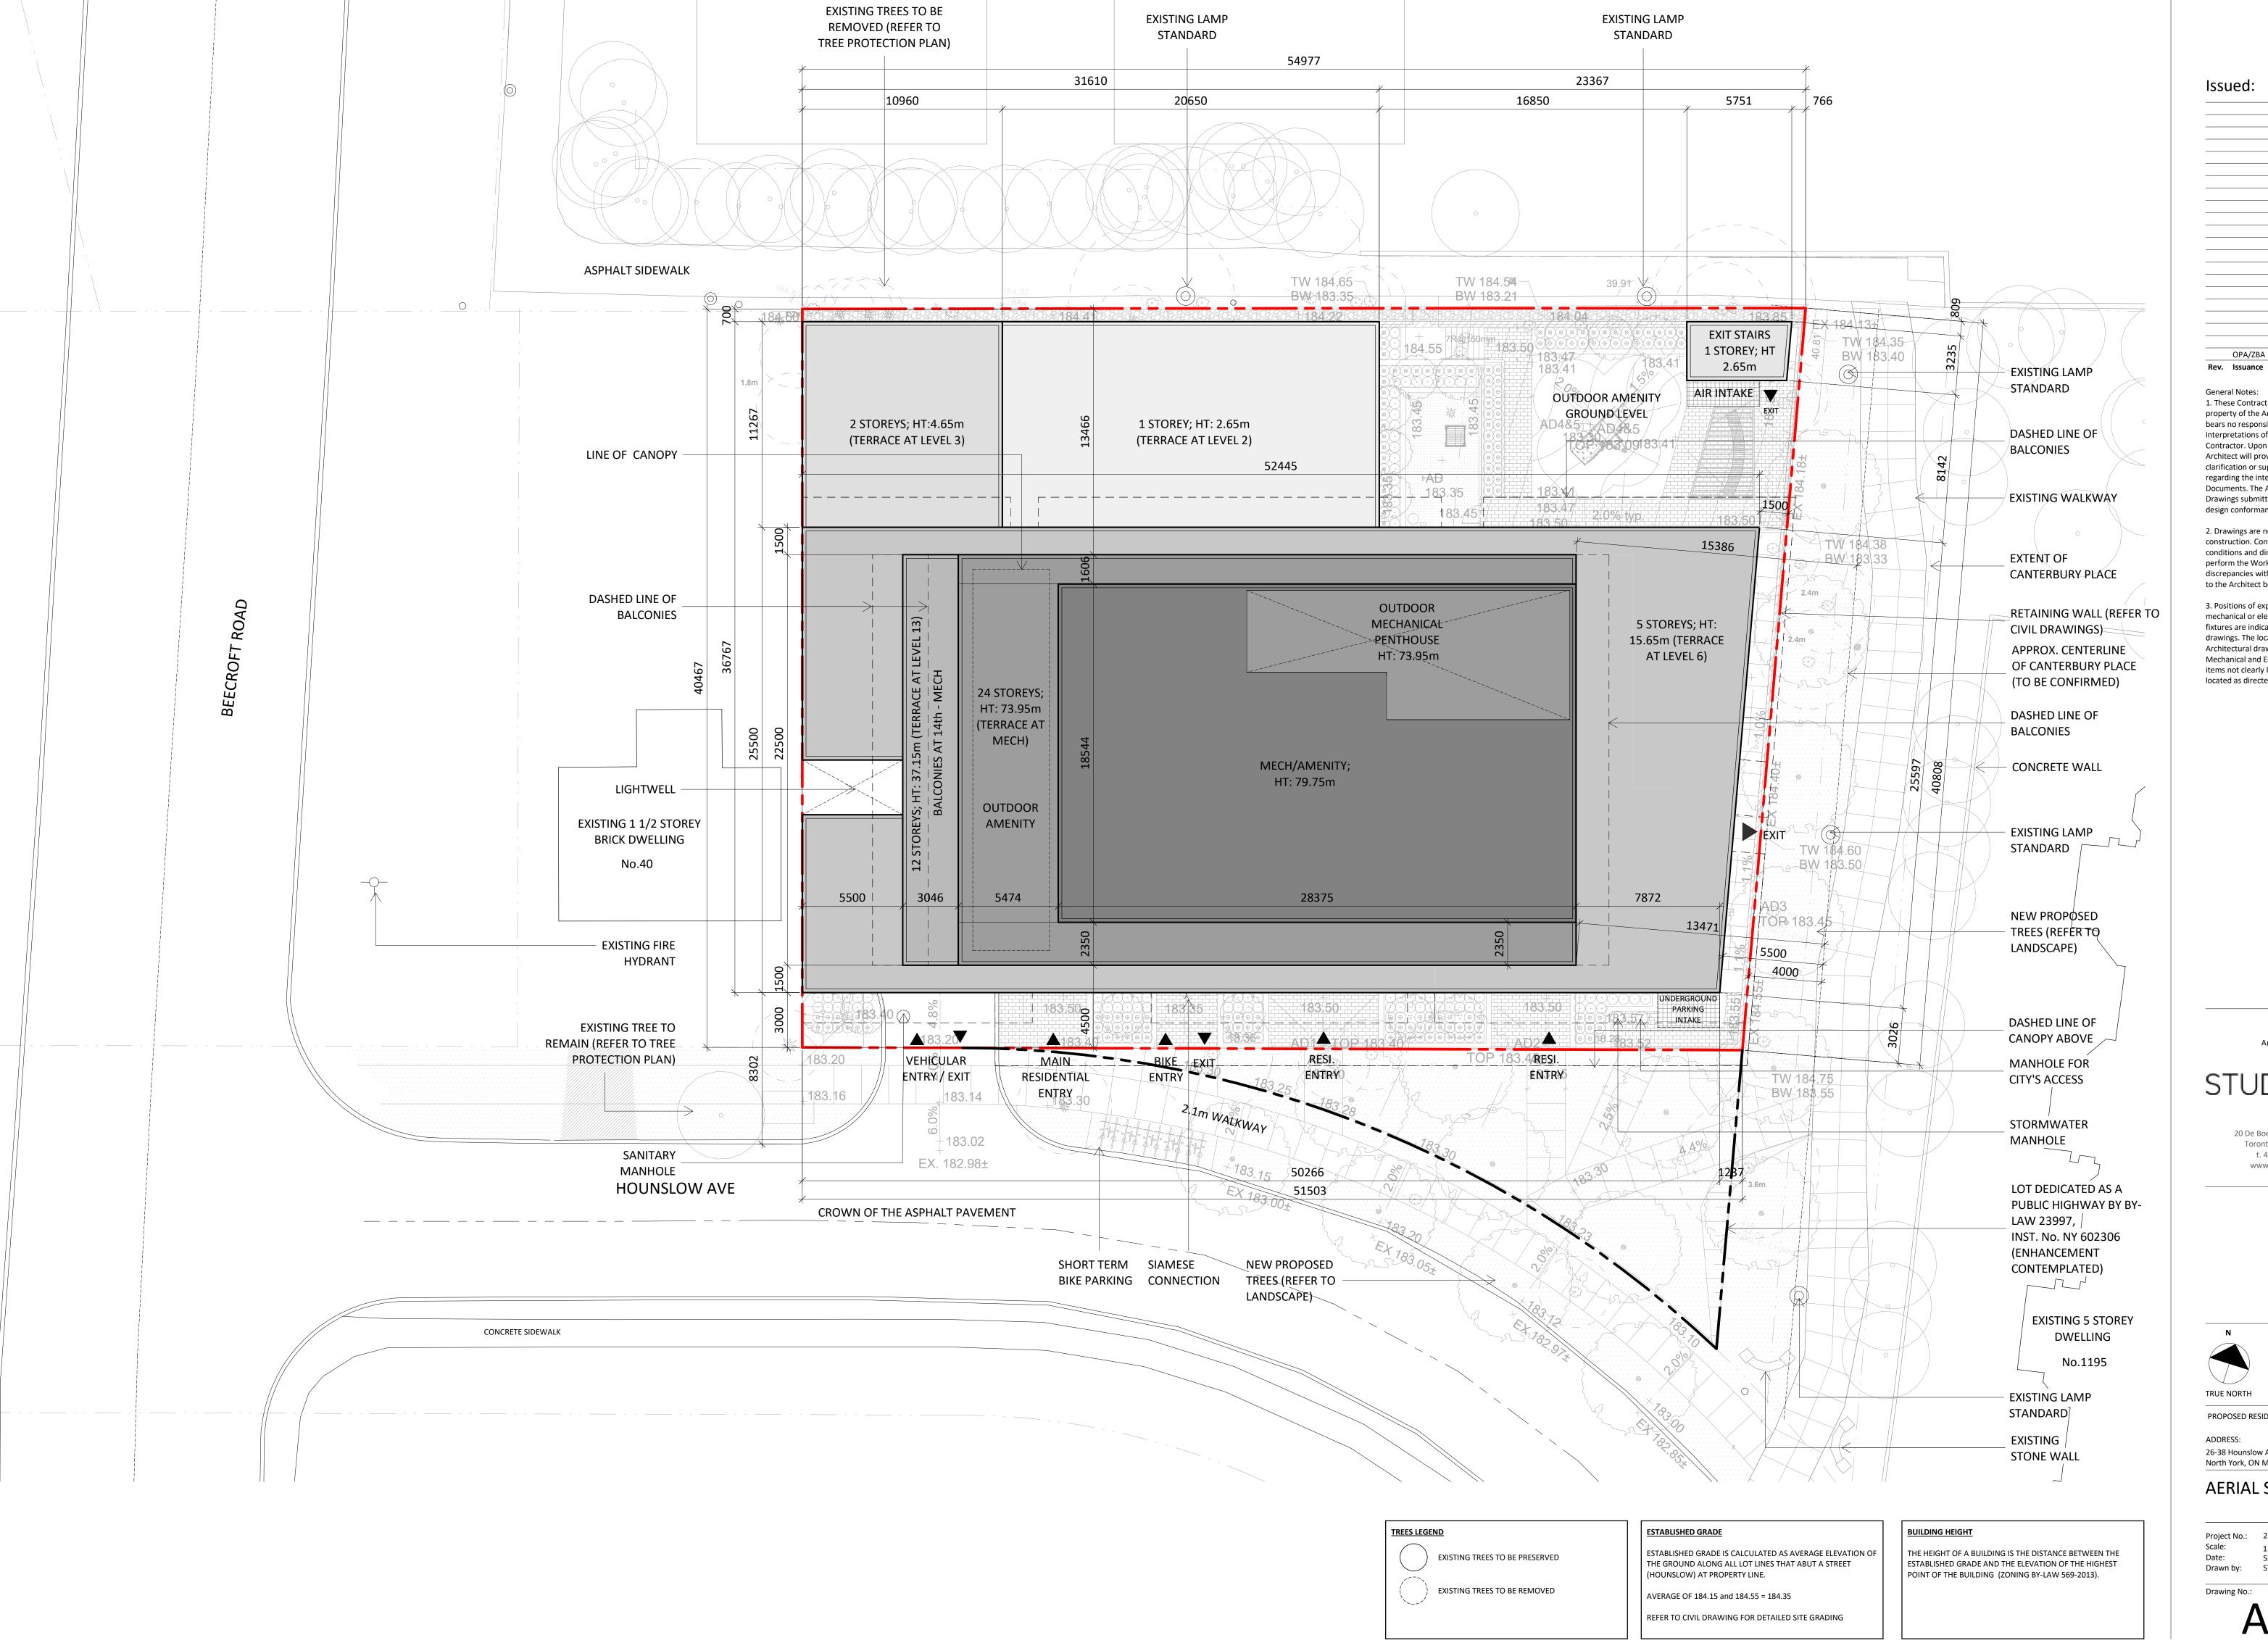ADDRESS: 26-38 Hounslow Ave, North York, ON M2N 2A8

AERIAL SITE PLAN

Project No.: 2224

1:150 SEPTEMBER 29, 2023 STUDIO JCI Drawn by:



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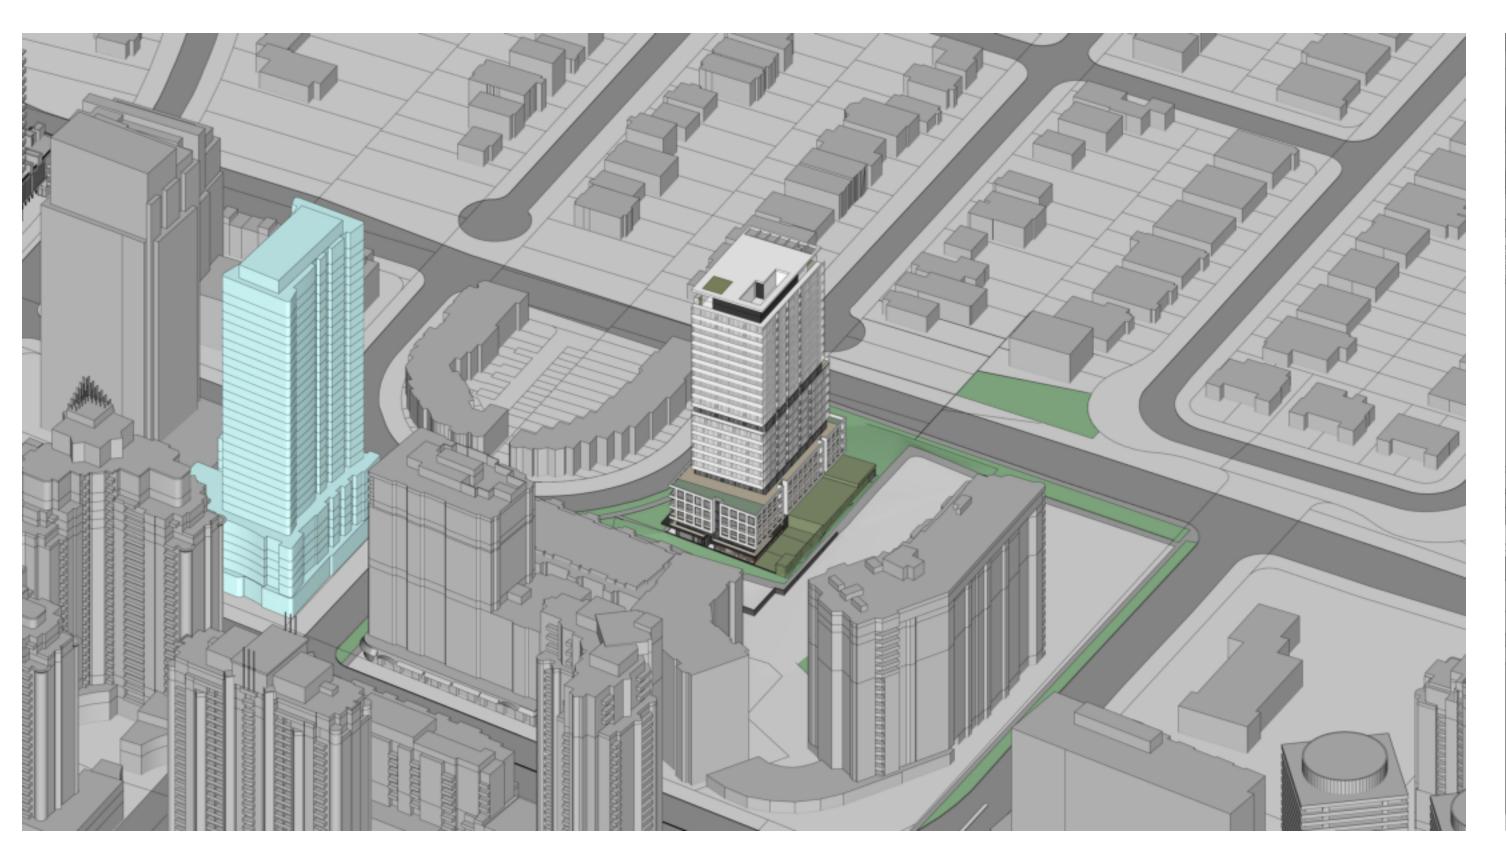
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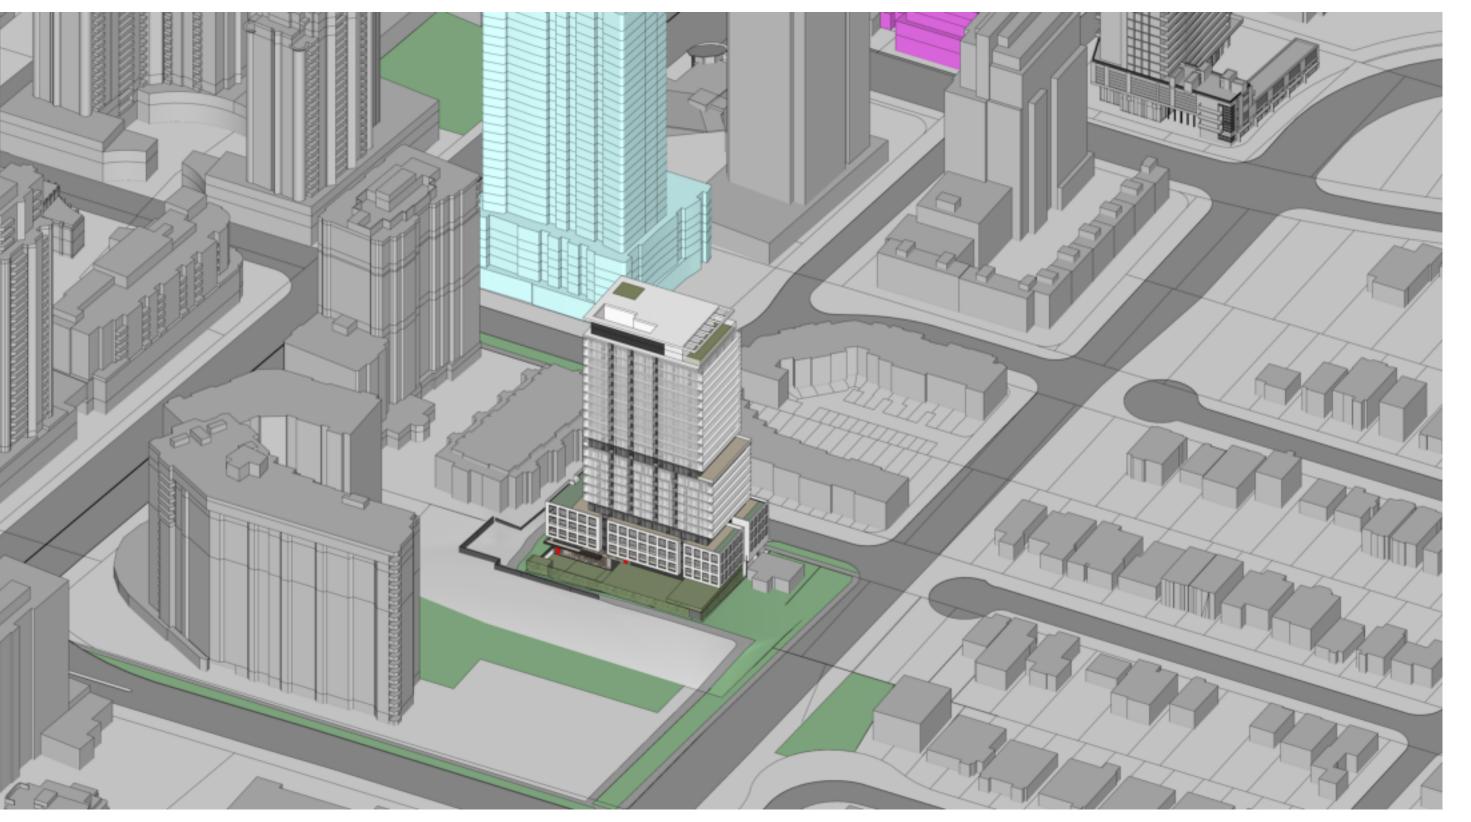
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GROUND FLOOR

SITE PLAN Project No.: 2224 1:150


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NORTH EAST AERIAL VIEW

NORTH WEST AERIAL VIEW



SOUTH EAST AERIAL VIEW

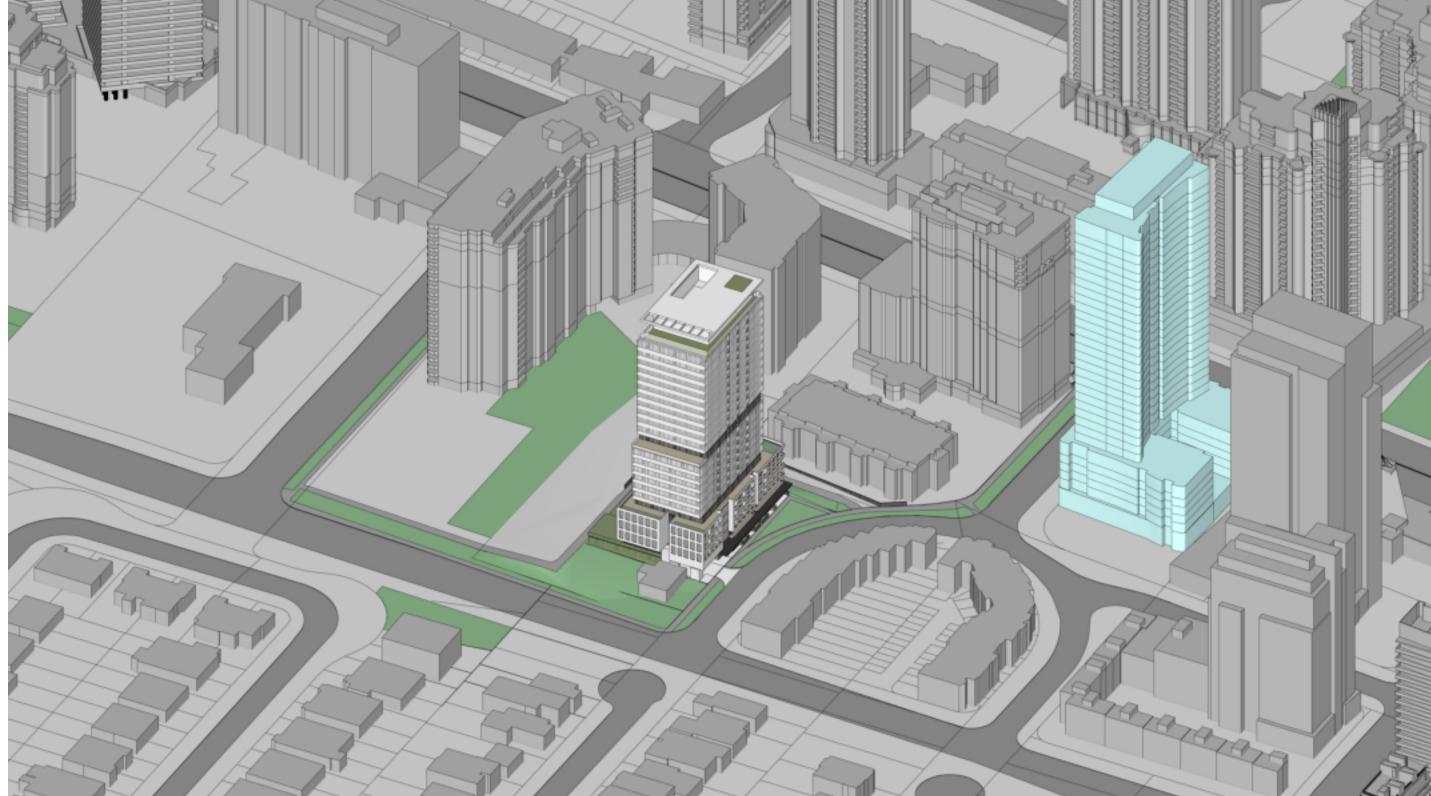

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3D VIEWS 1

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Note: All illustrations are artist's concept. E.&O.E

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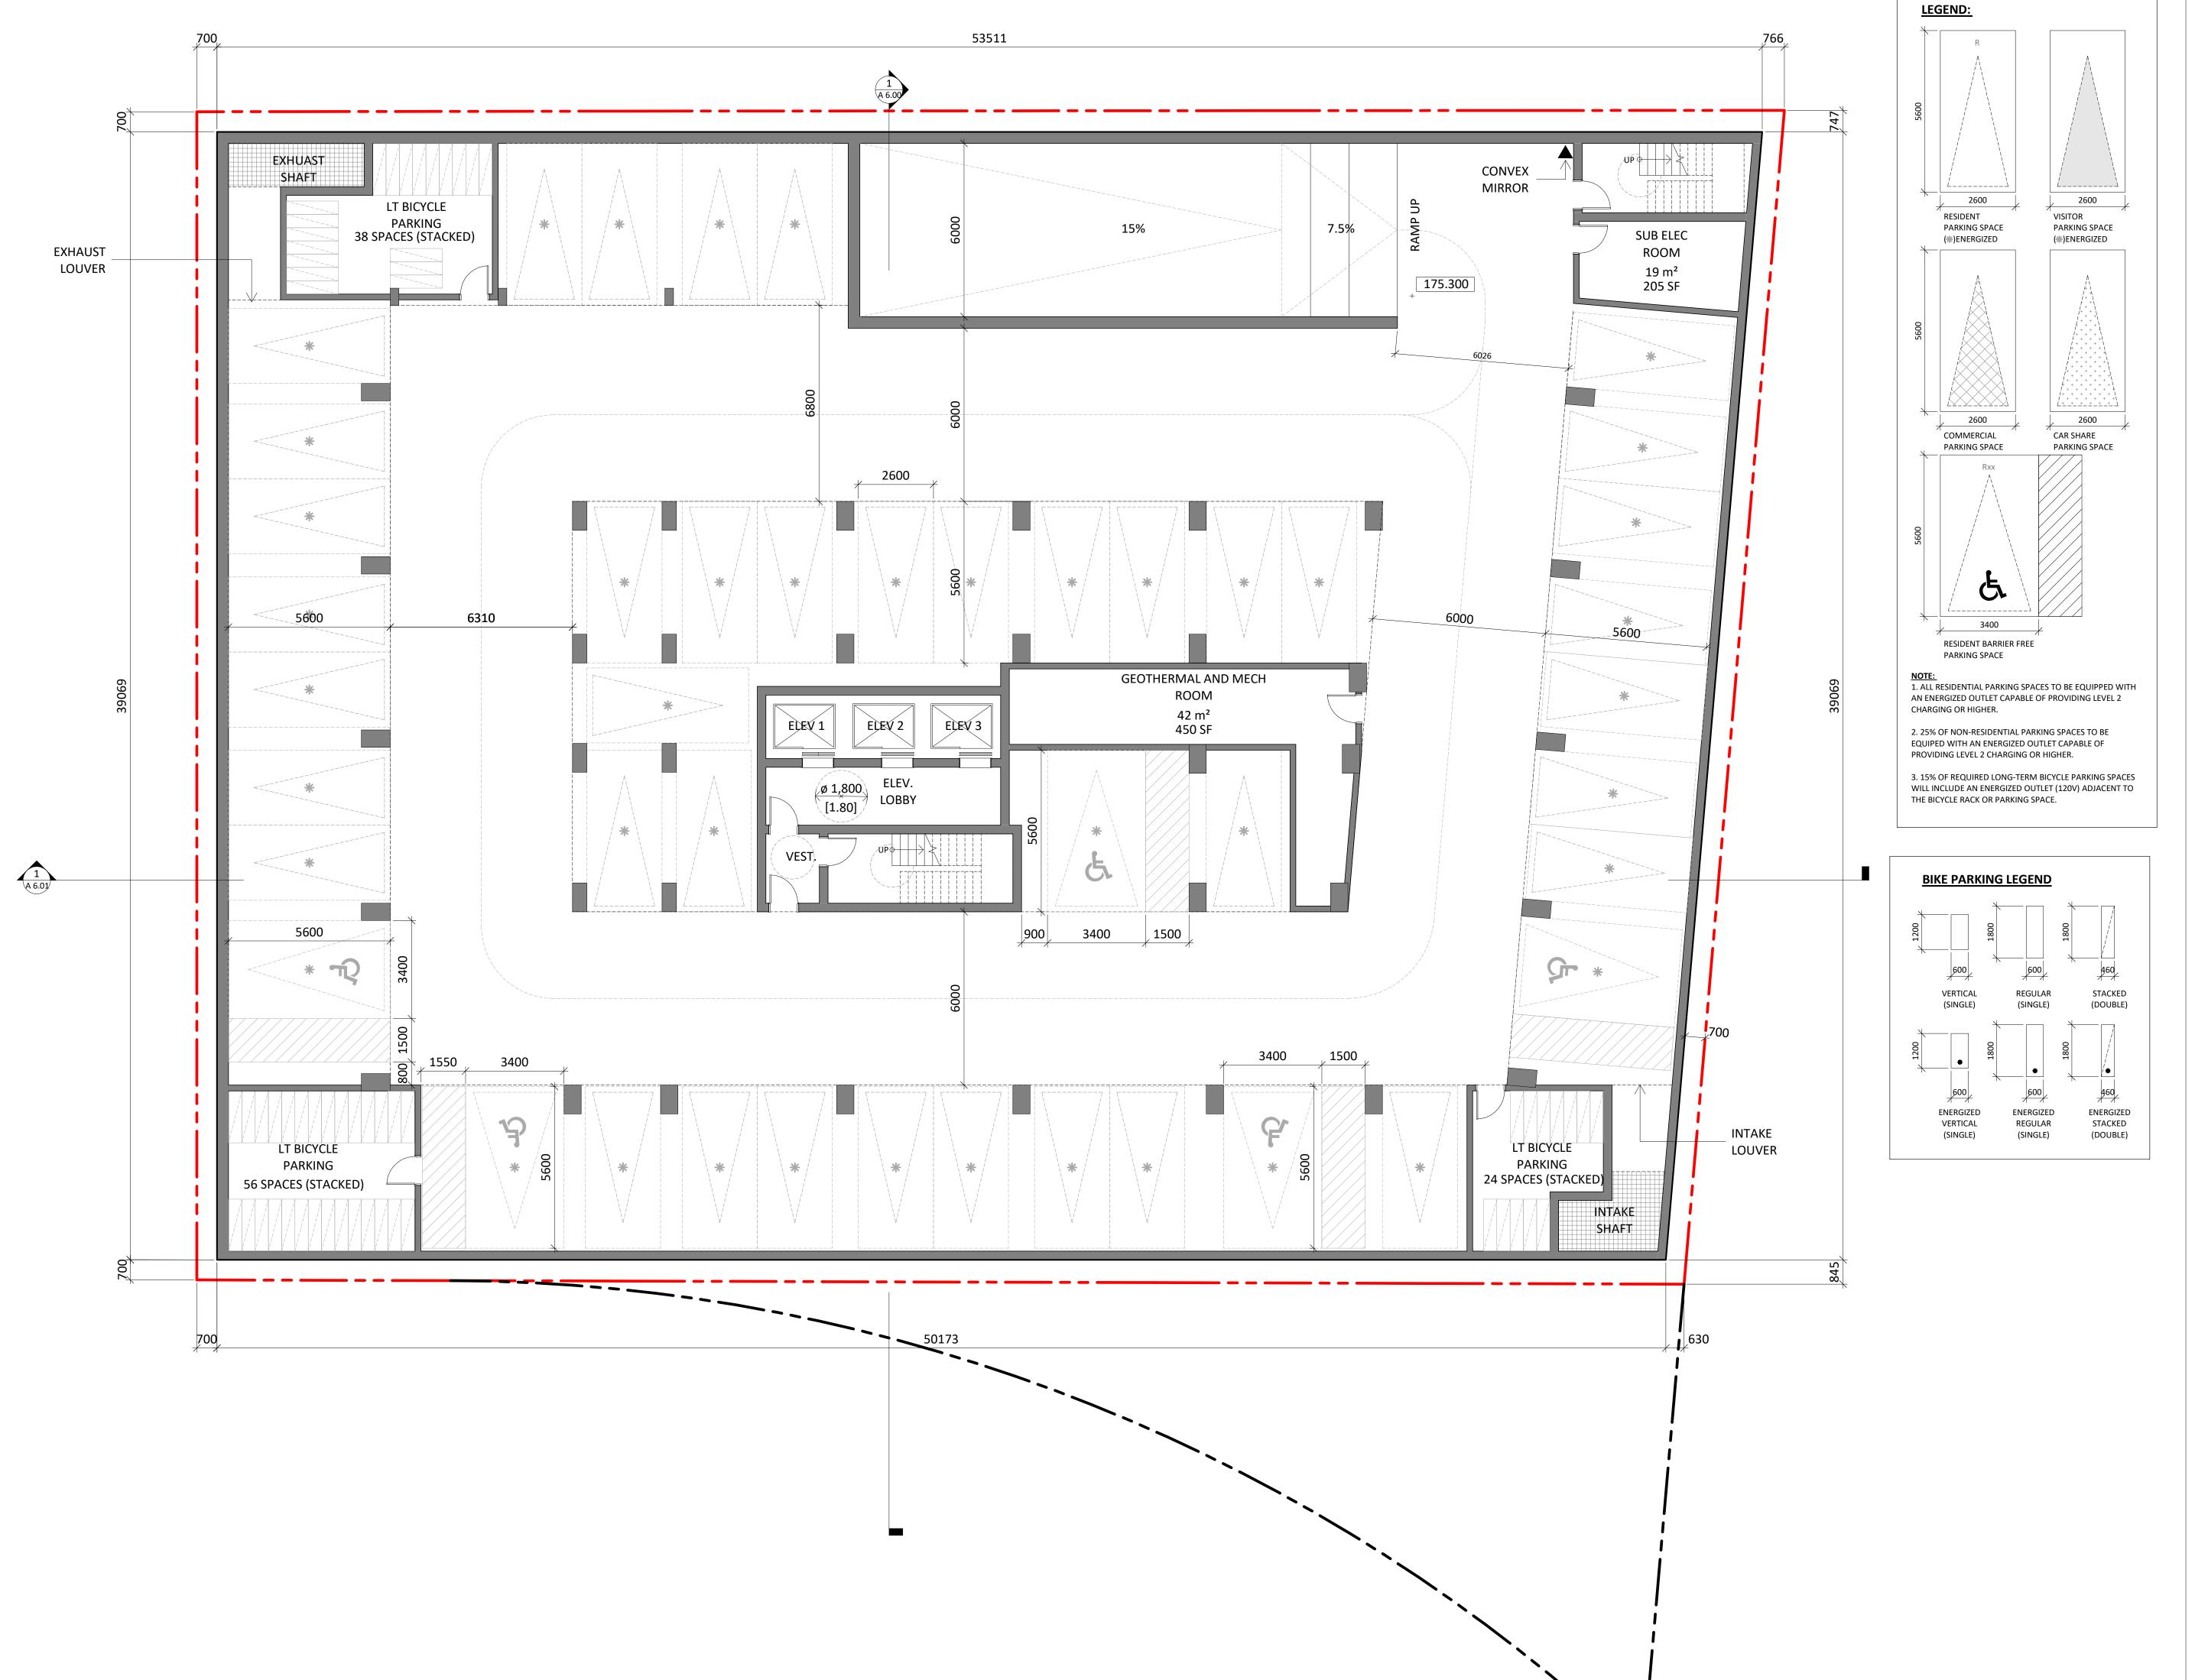
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3D VIEWS 2

Project No.: 2 Scale:

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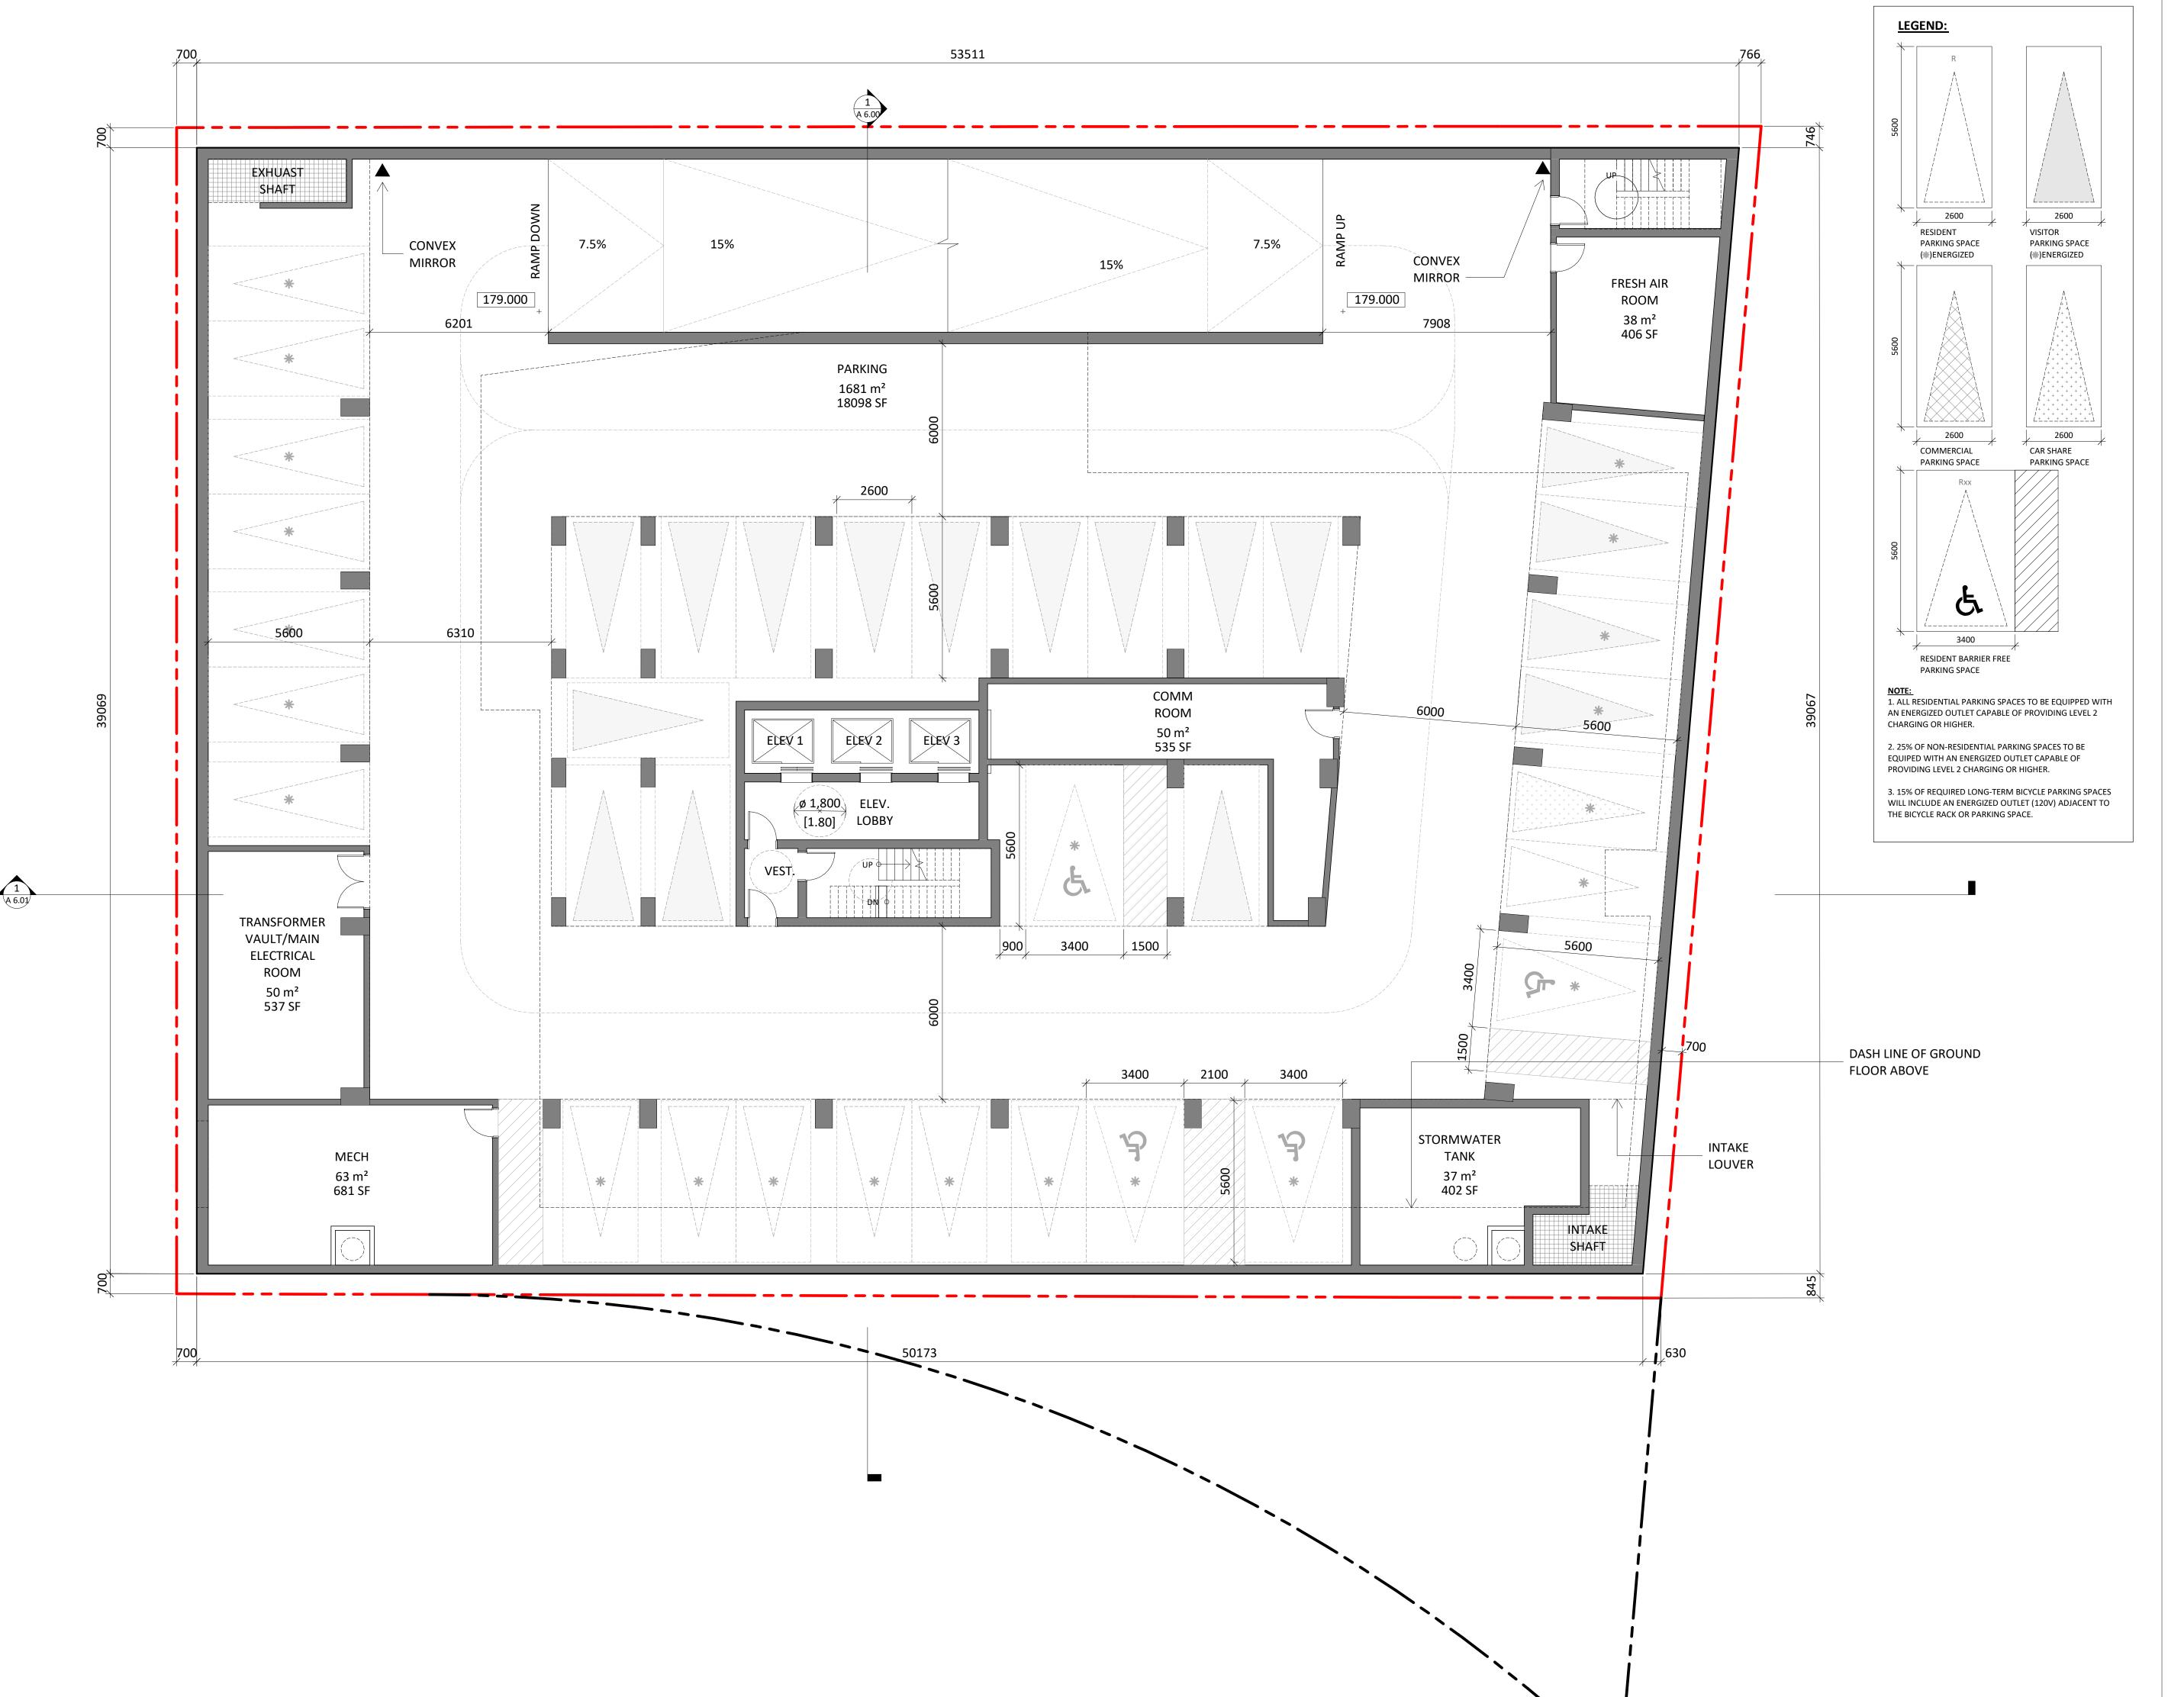
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PARKING LEVEL 2

Project No.: 2224 1:100 Date: SEPTEMBER 29, 2023
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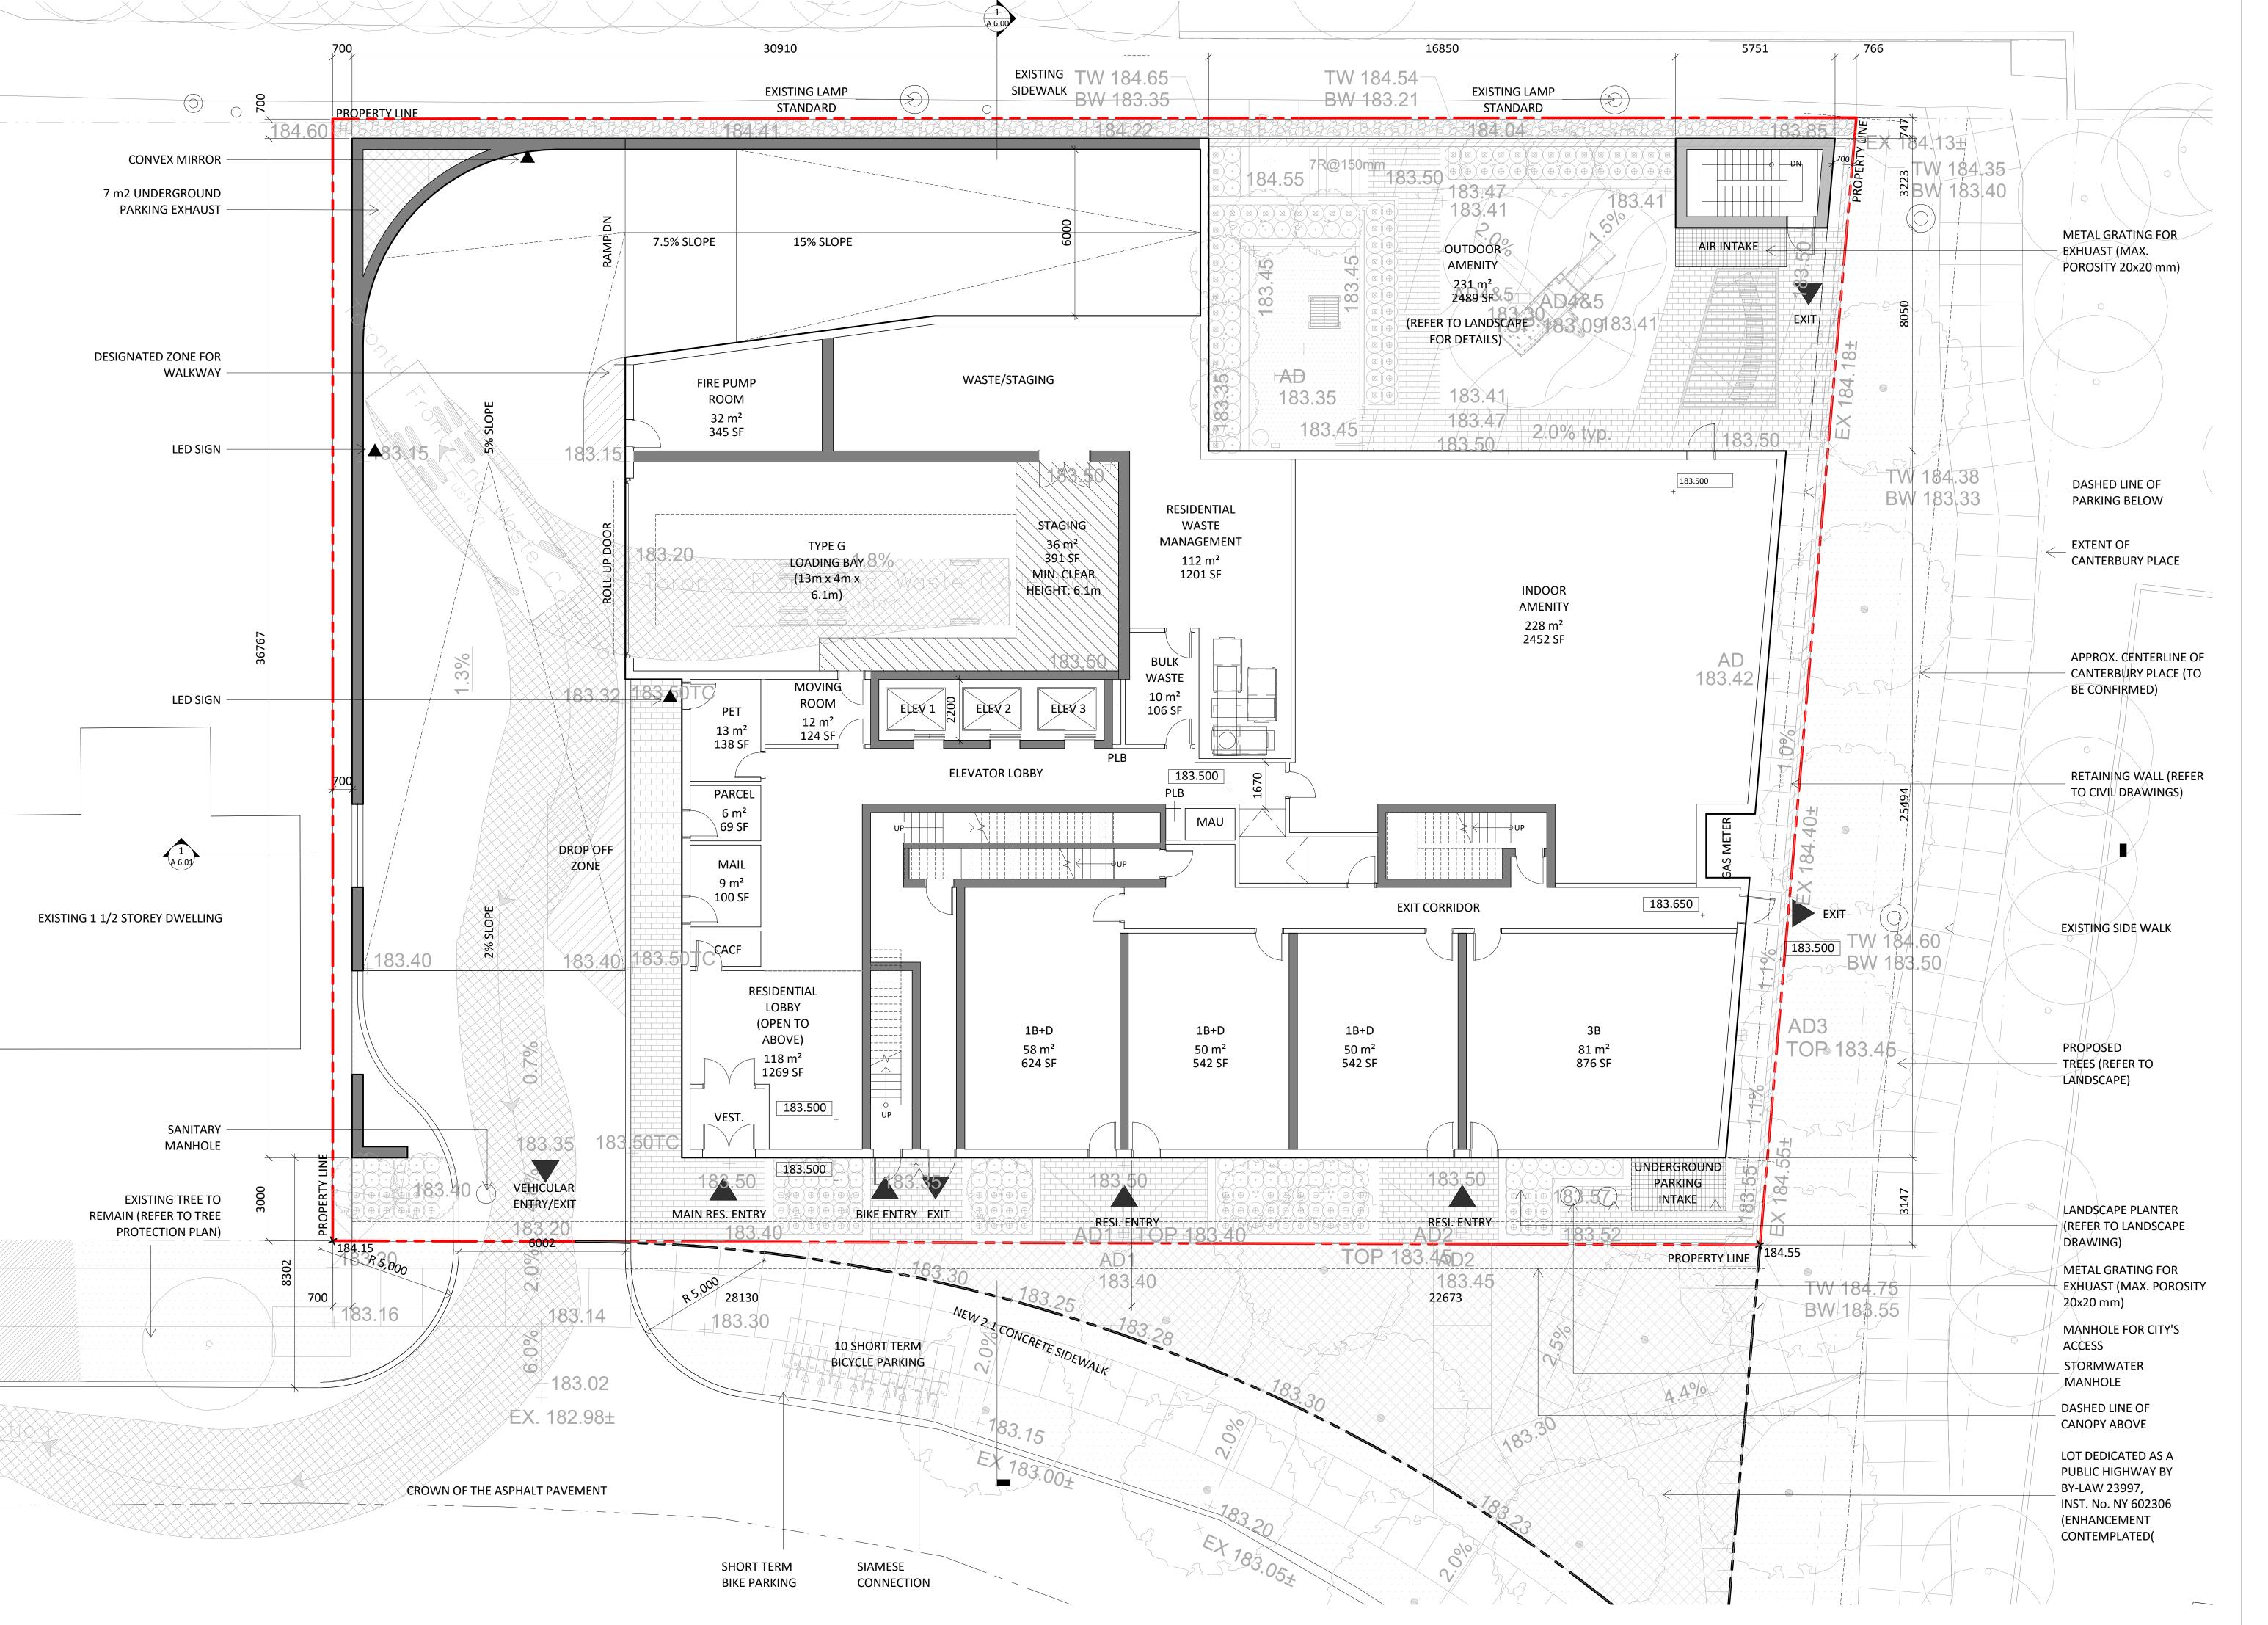
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PARKING LEVEL 1

Project No.: 2224 1:100 Date: SEPTEMBER 29, 2023
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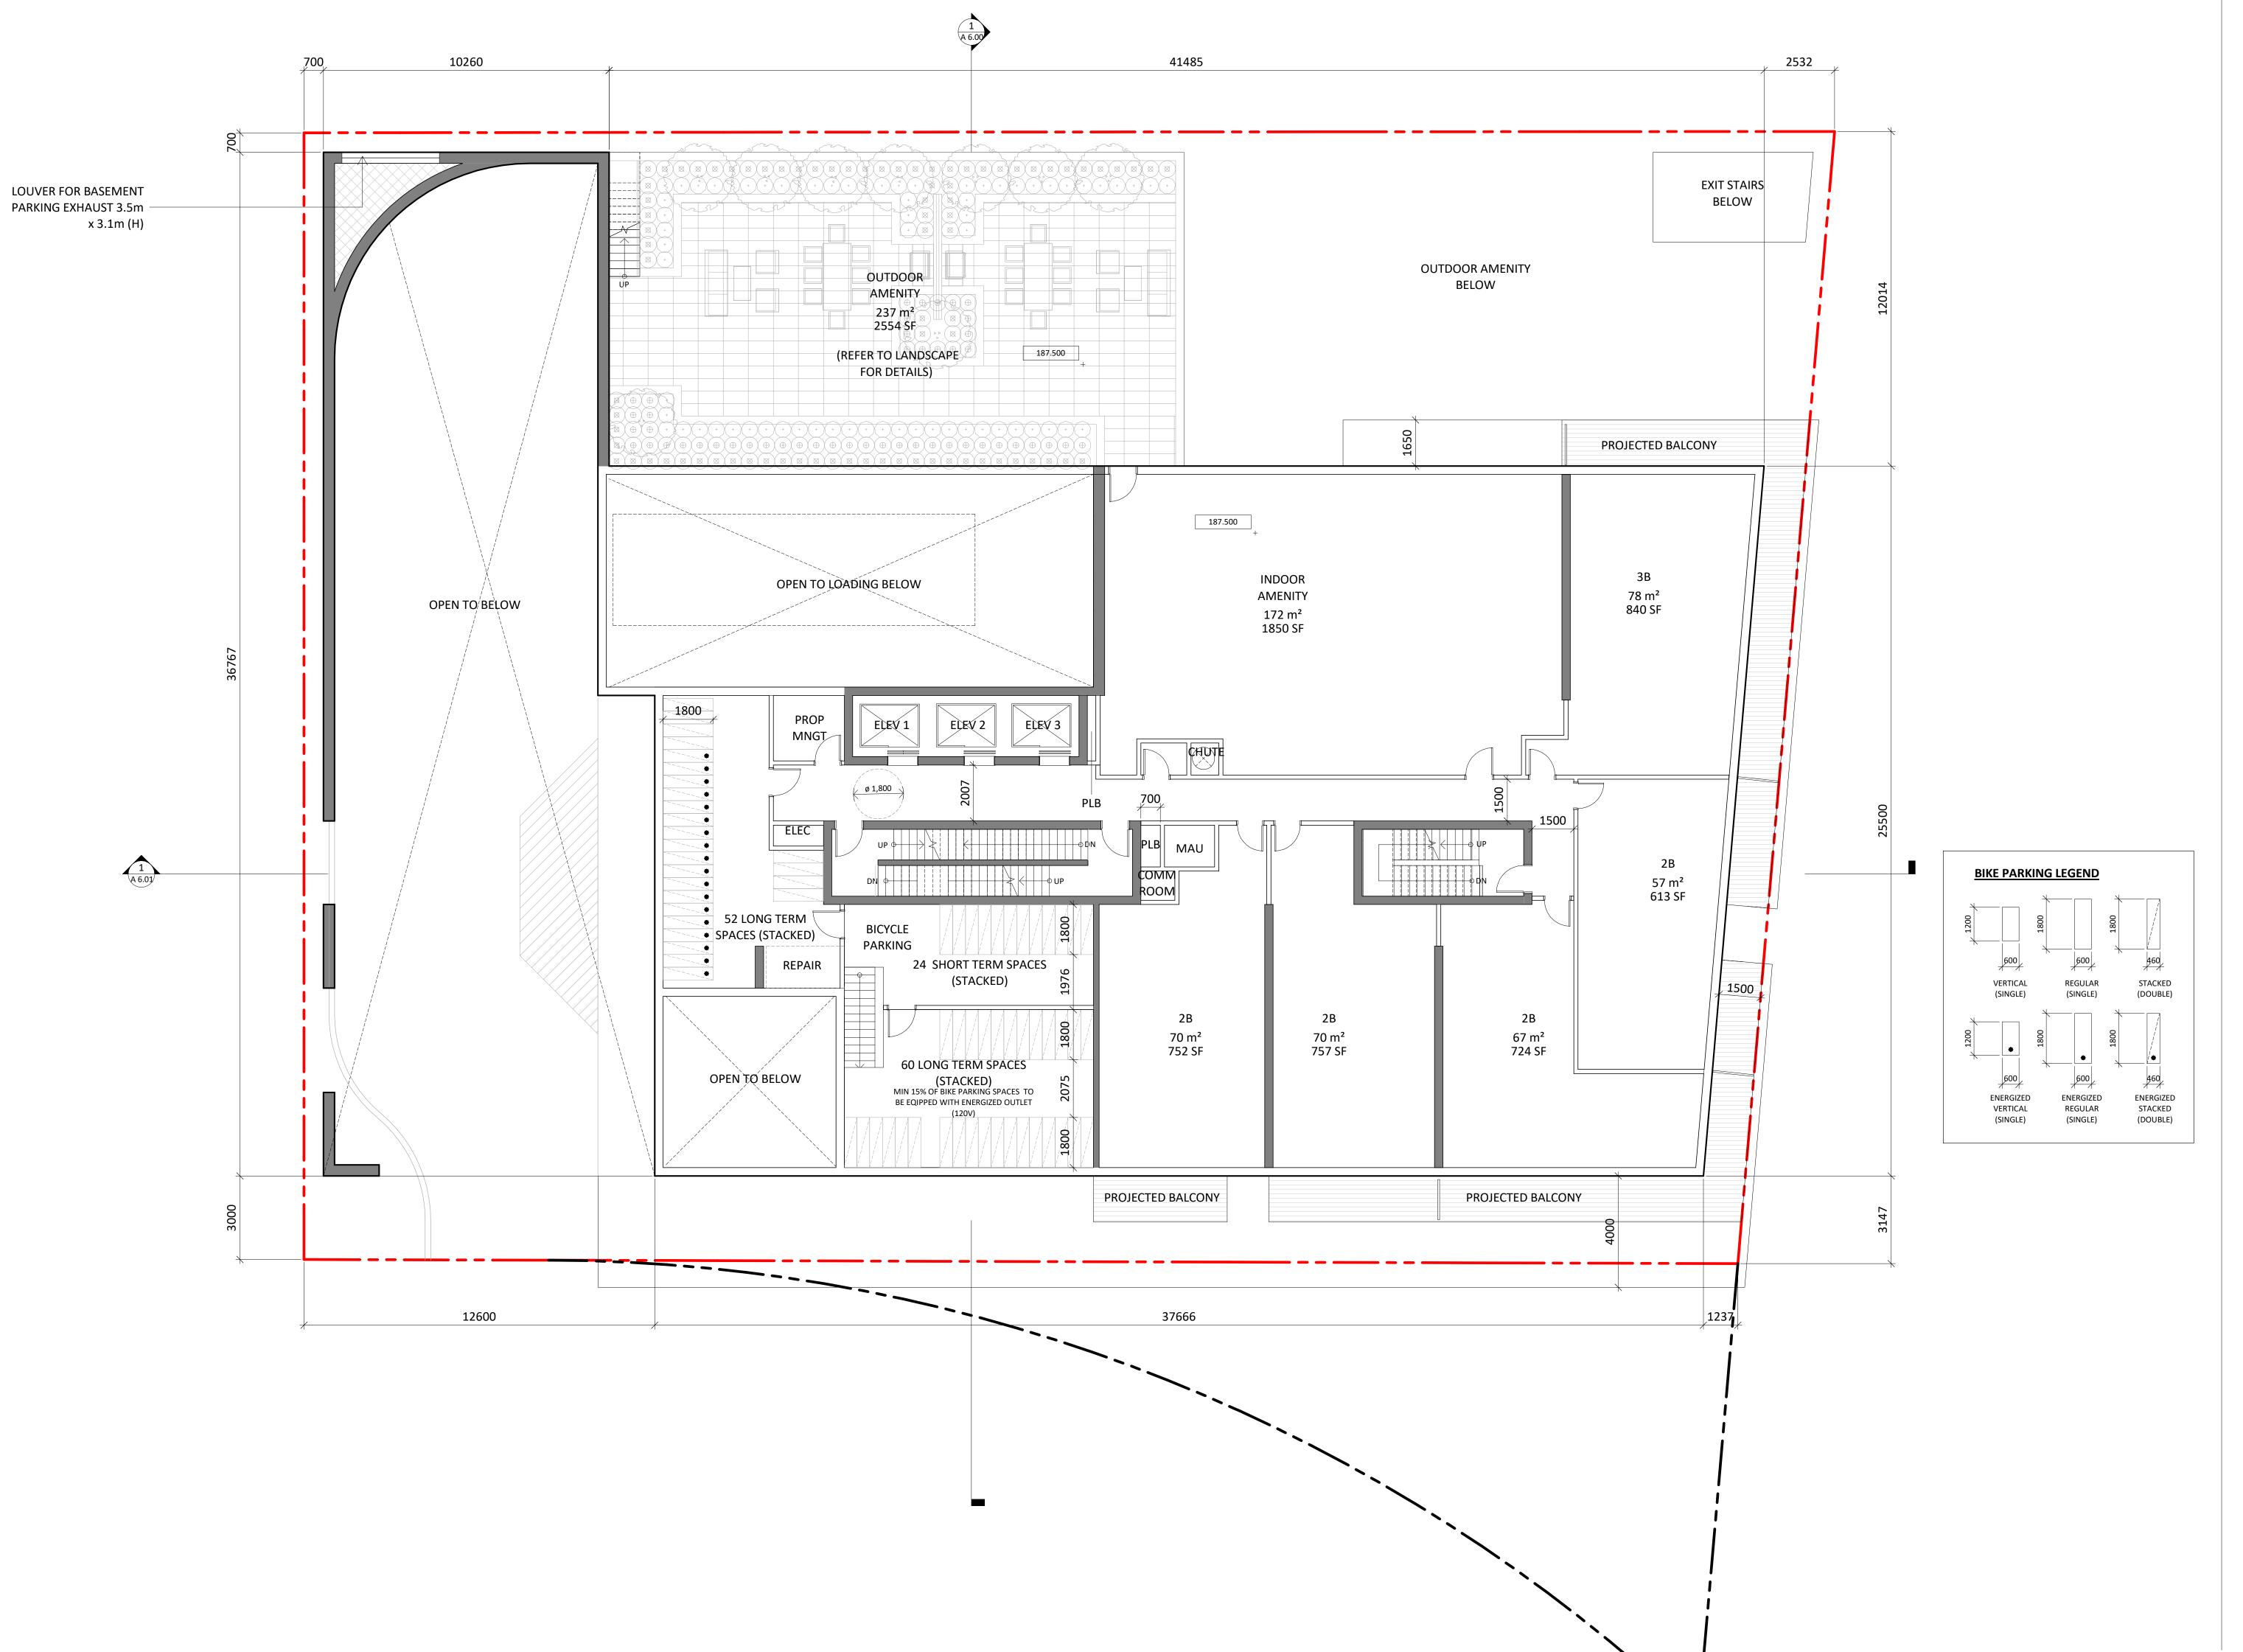
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GROUND FLOOR

PLAN

Project No.: 2224 Scale: 1:100 SEPTEMBER 29, 2023 STUDIO JCI Drawn by:



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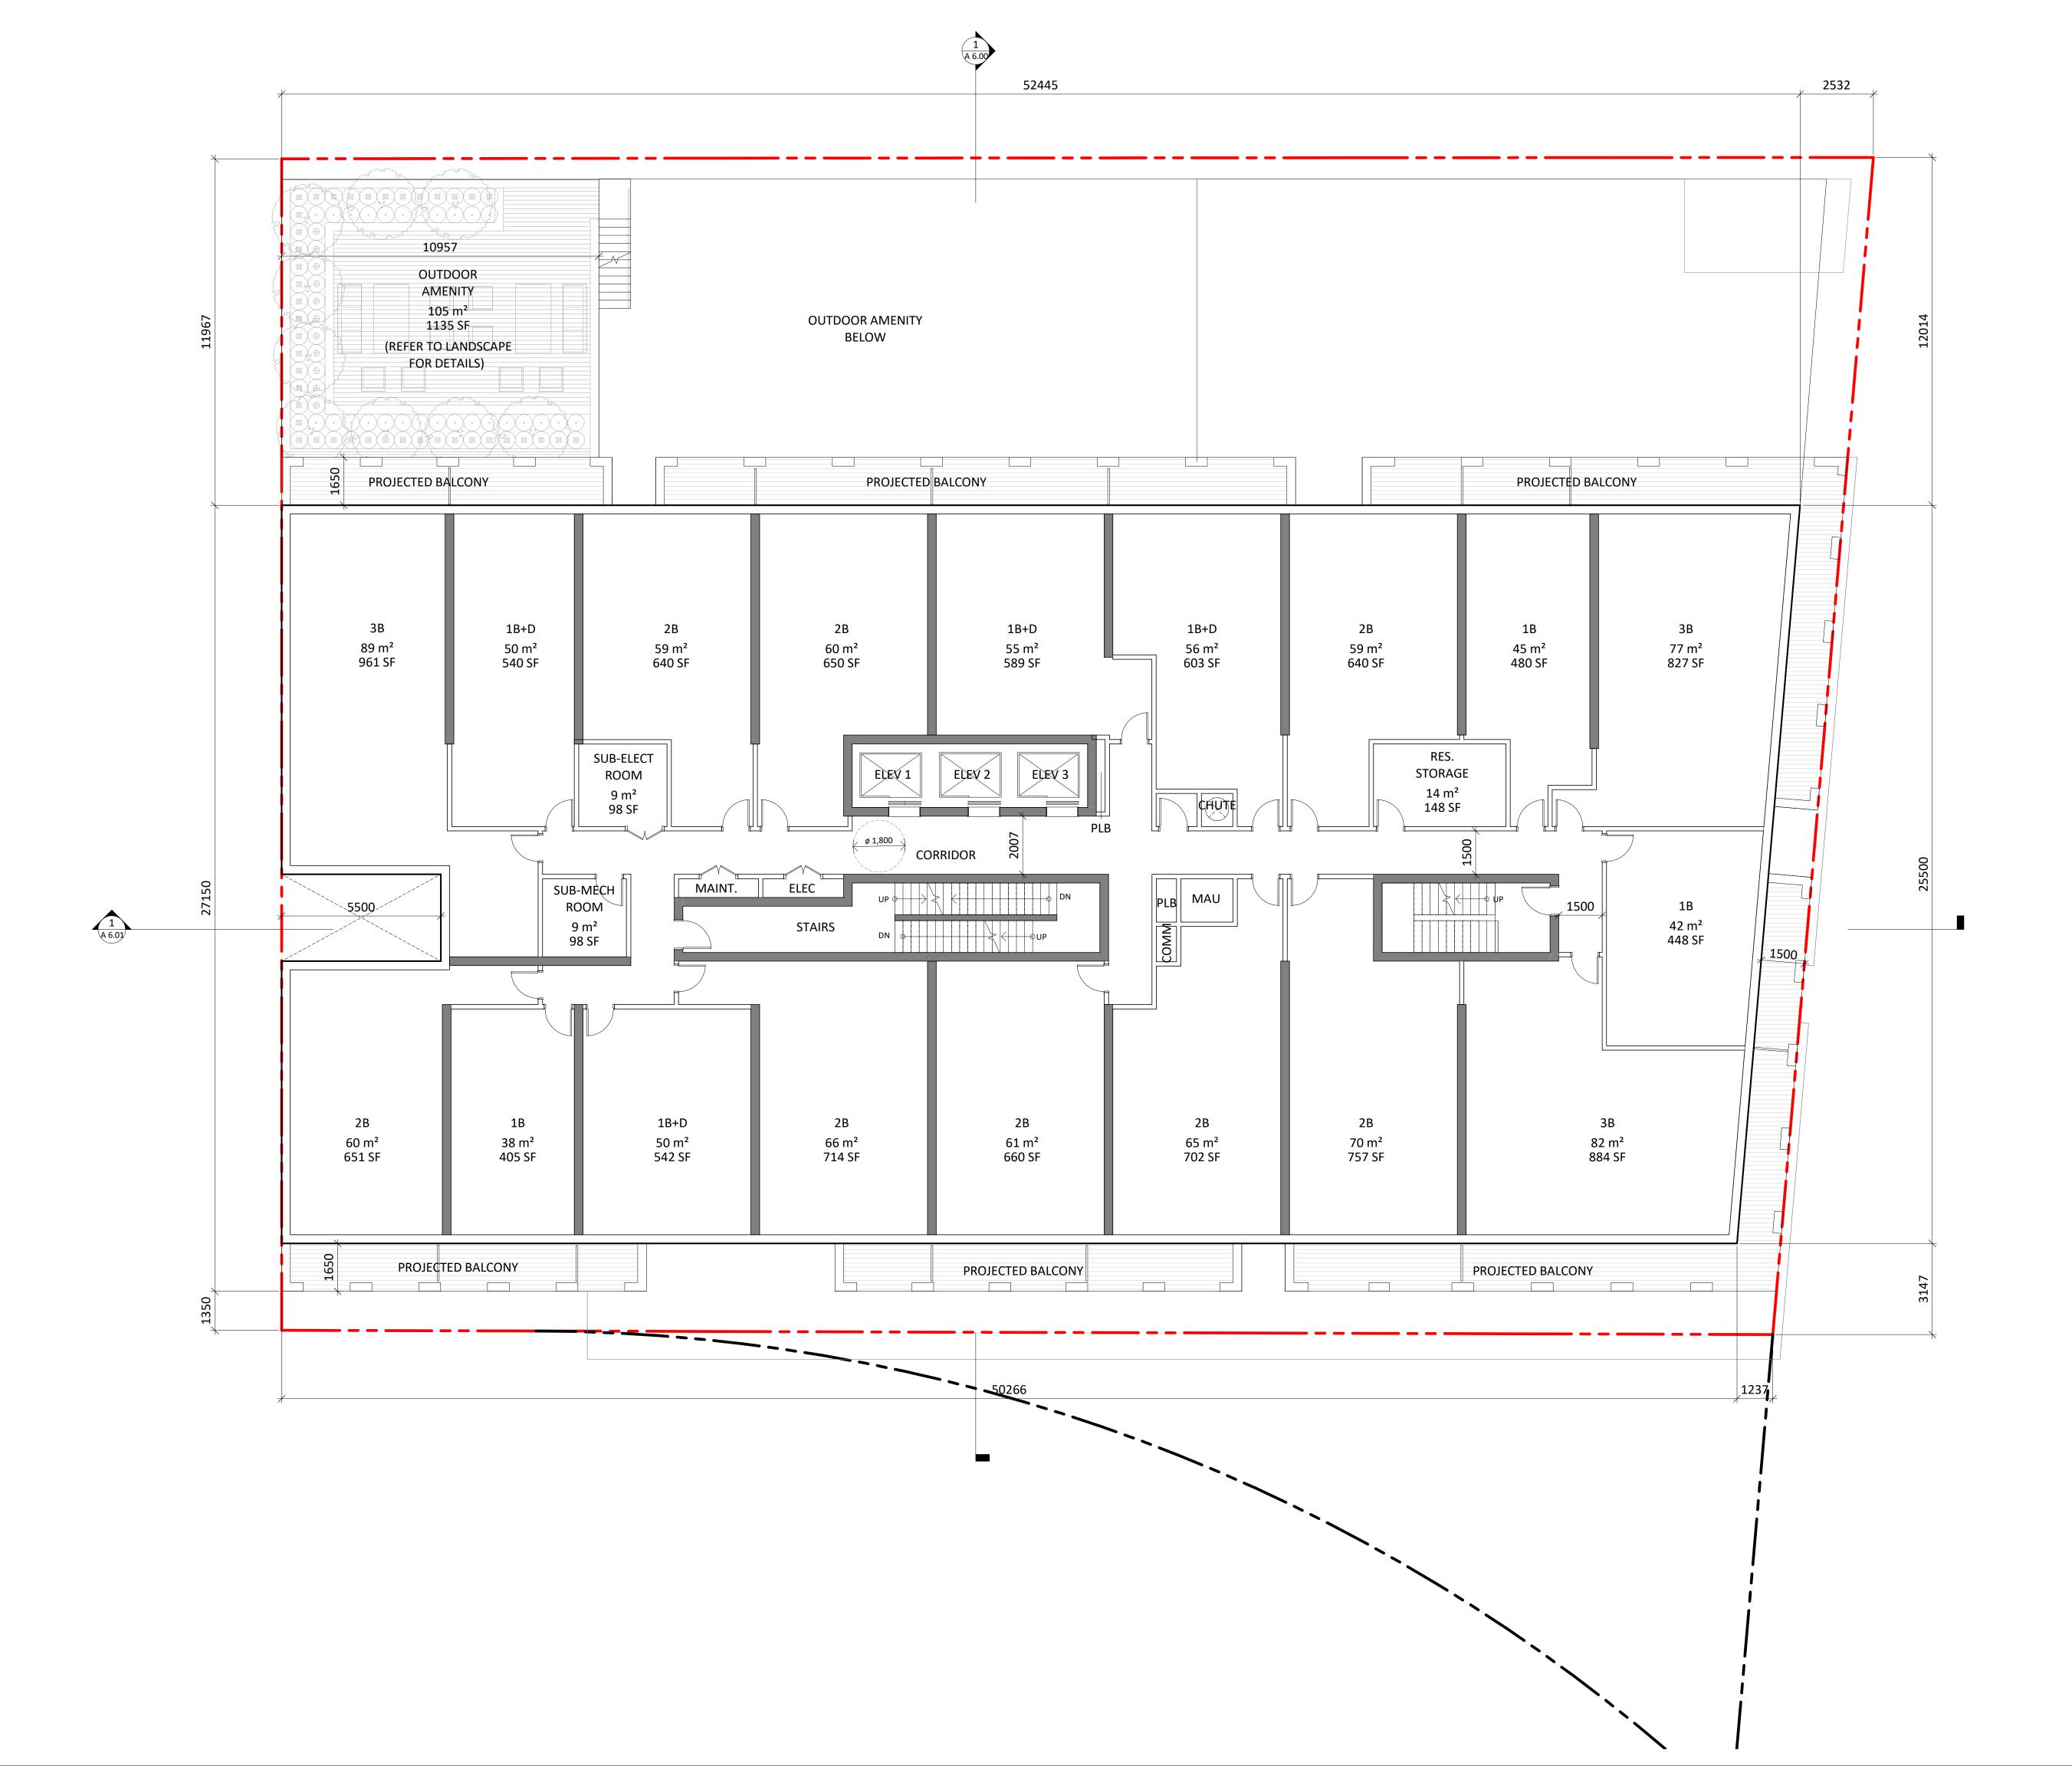
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LEVEL 2 FLOOR PLAN

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LEVEL 3 FLOOR PLAN


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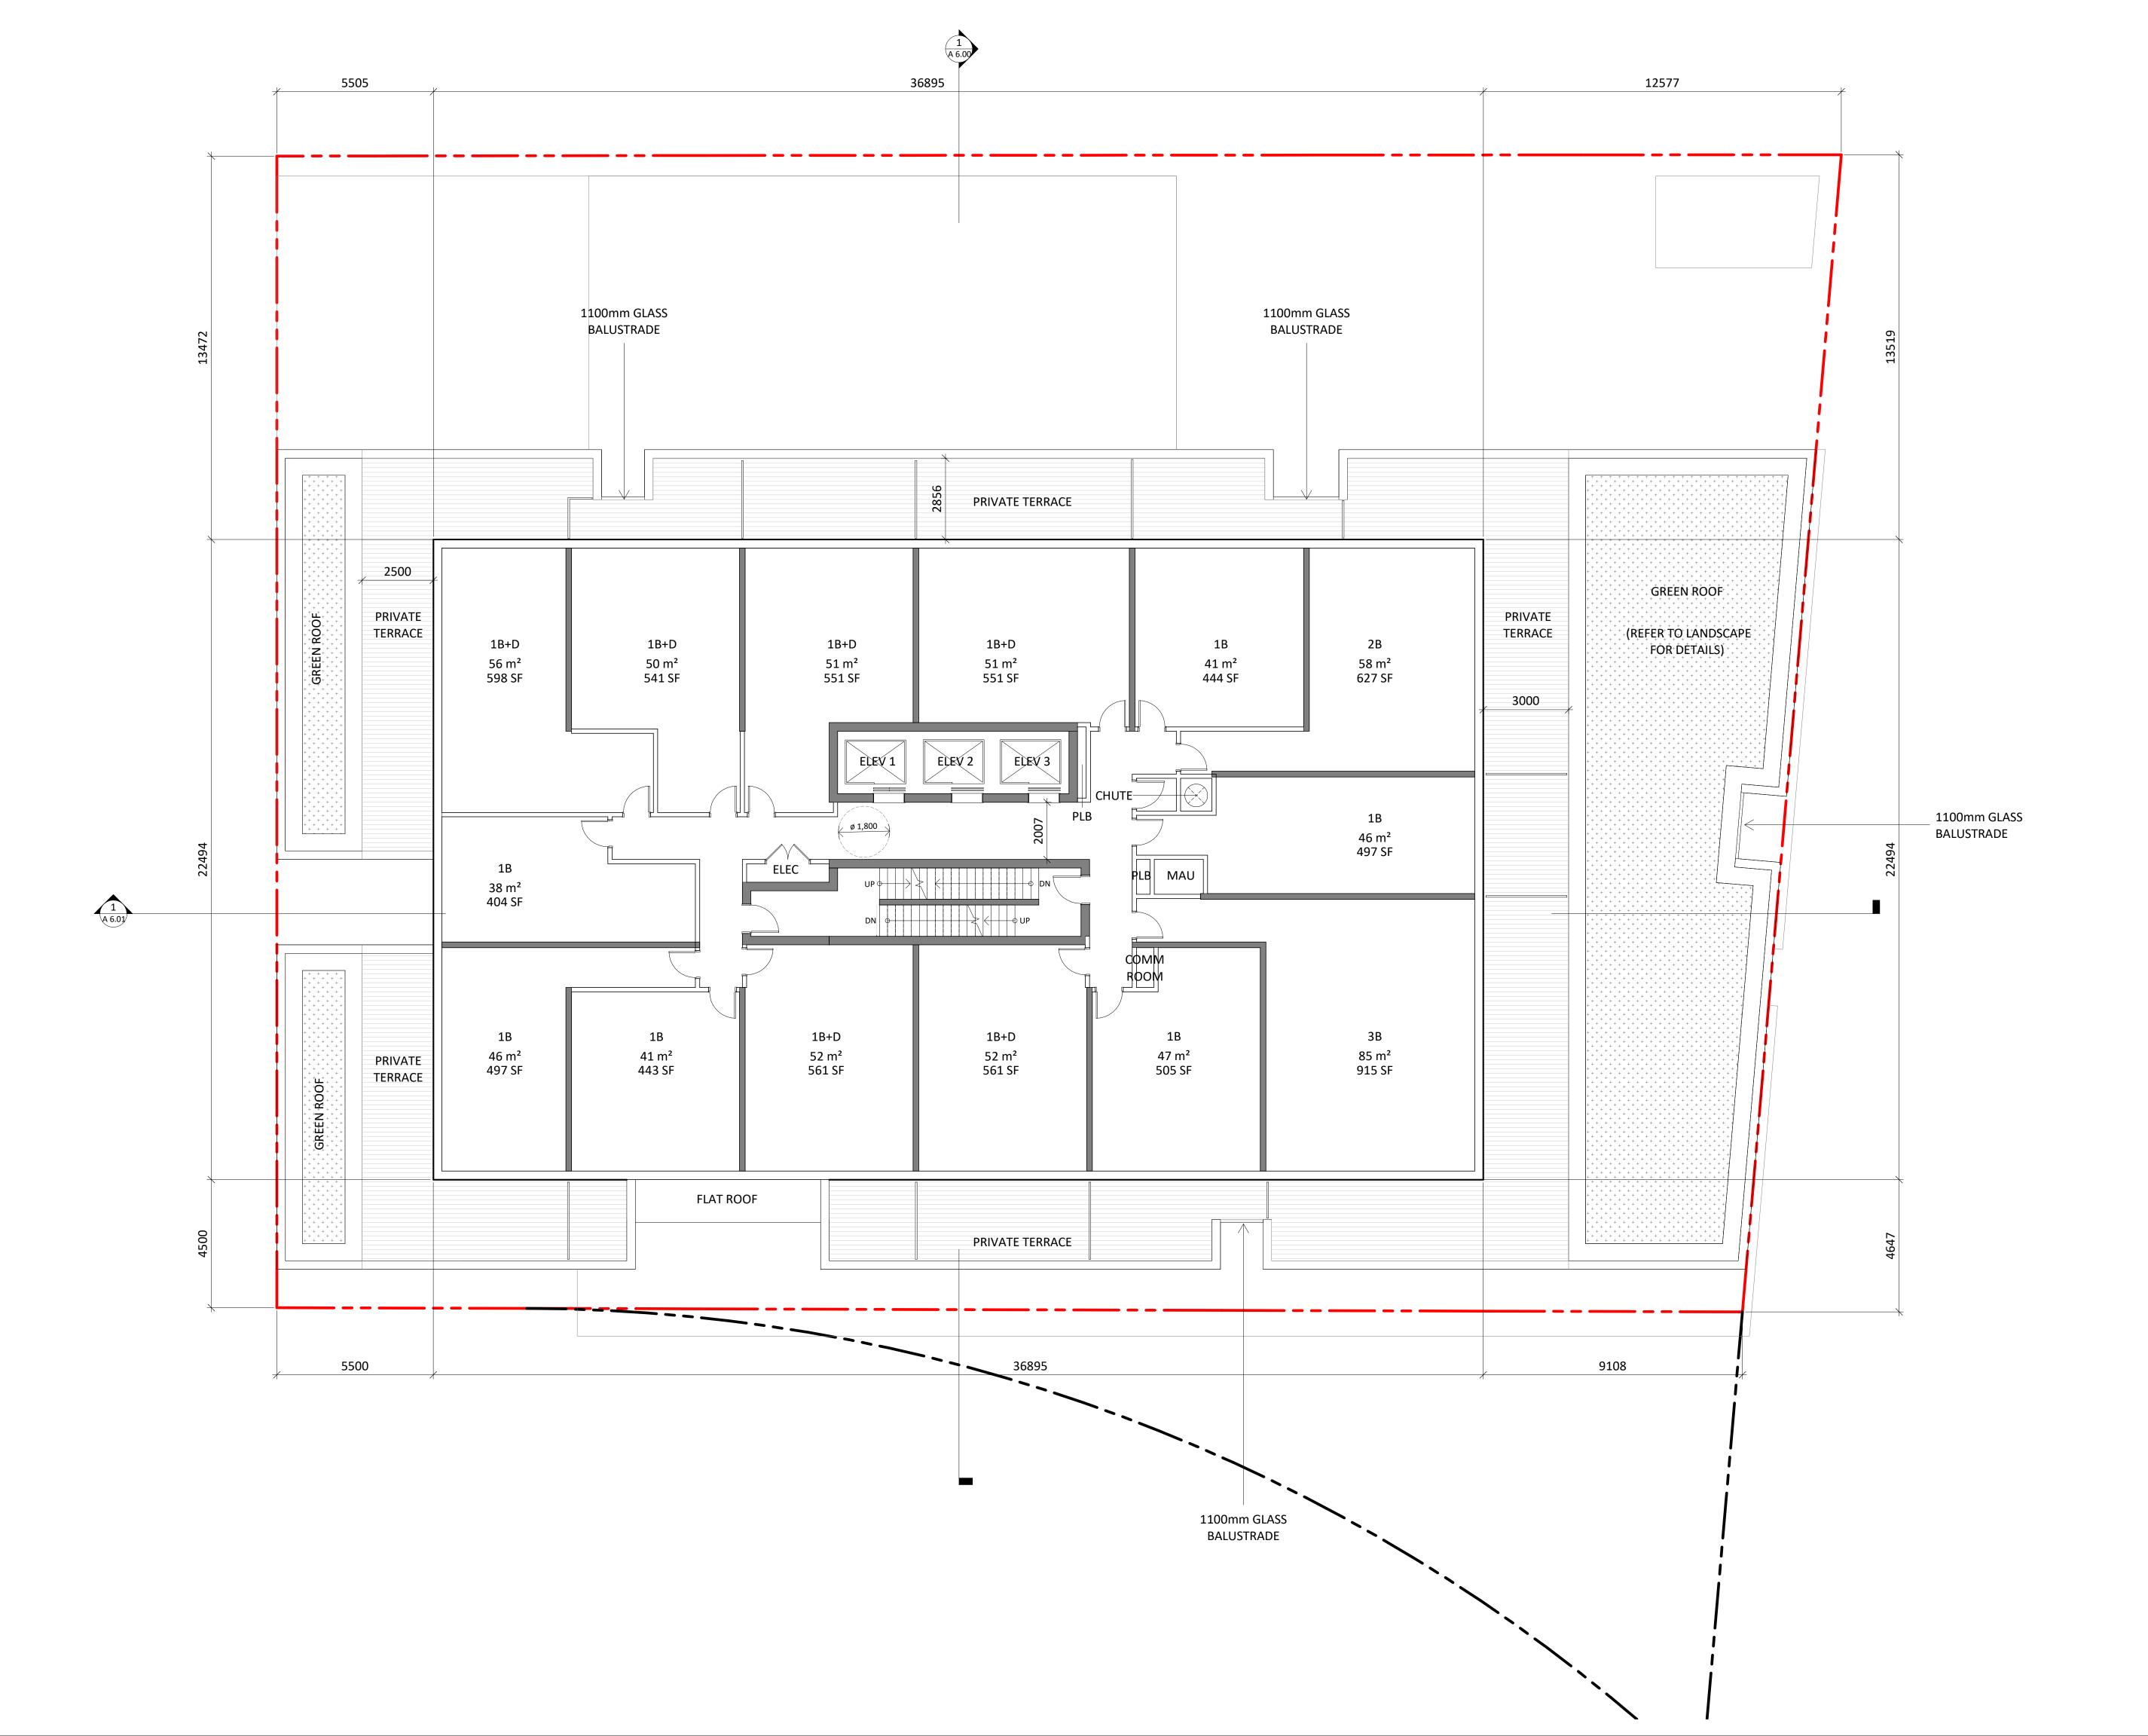
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LEVEL 4 to 5 FLOOR PLAN

Project No.: 2224
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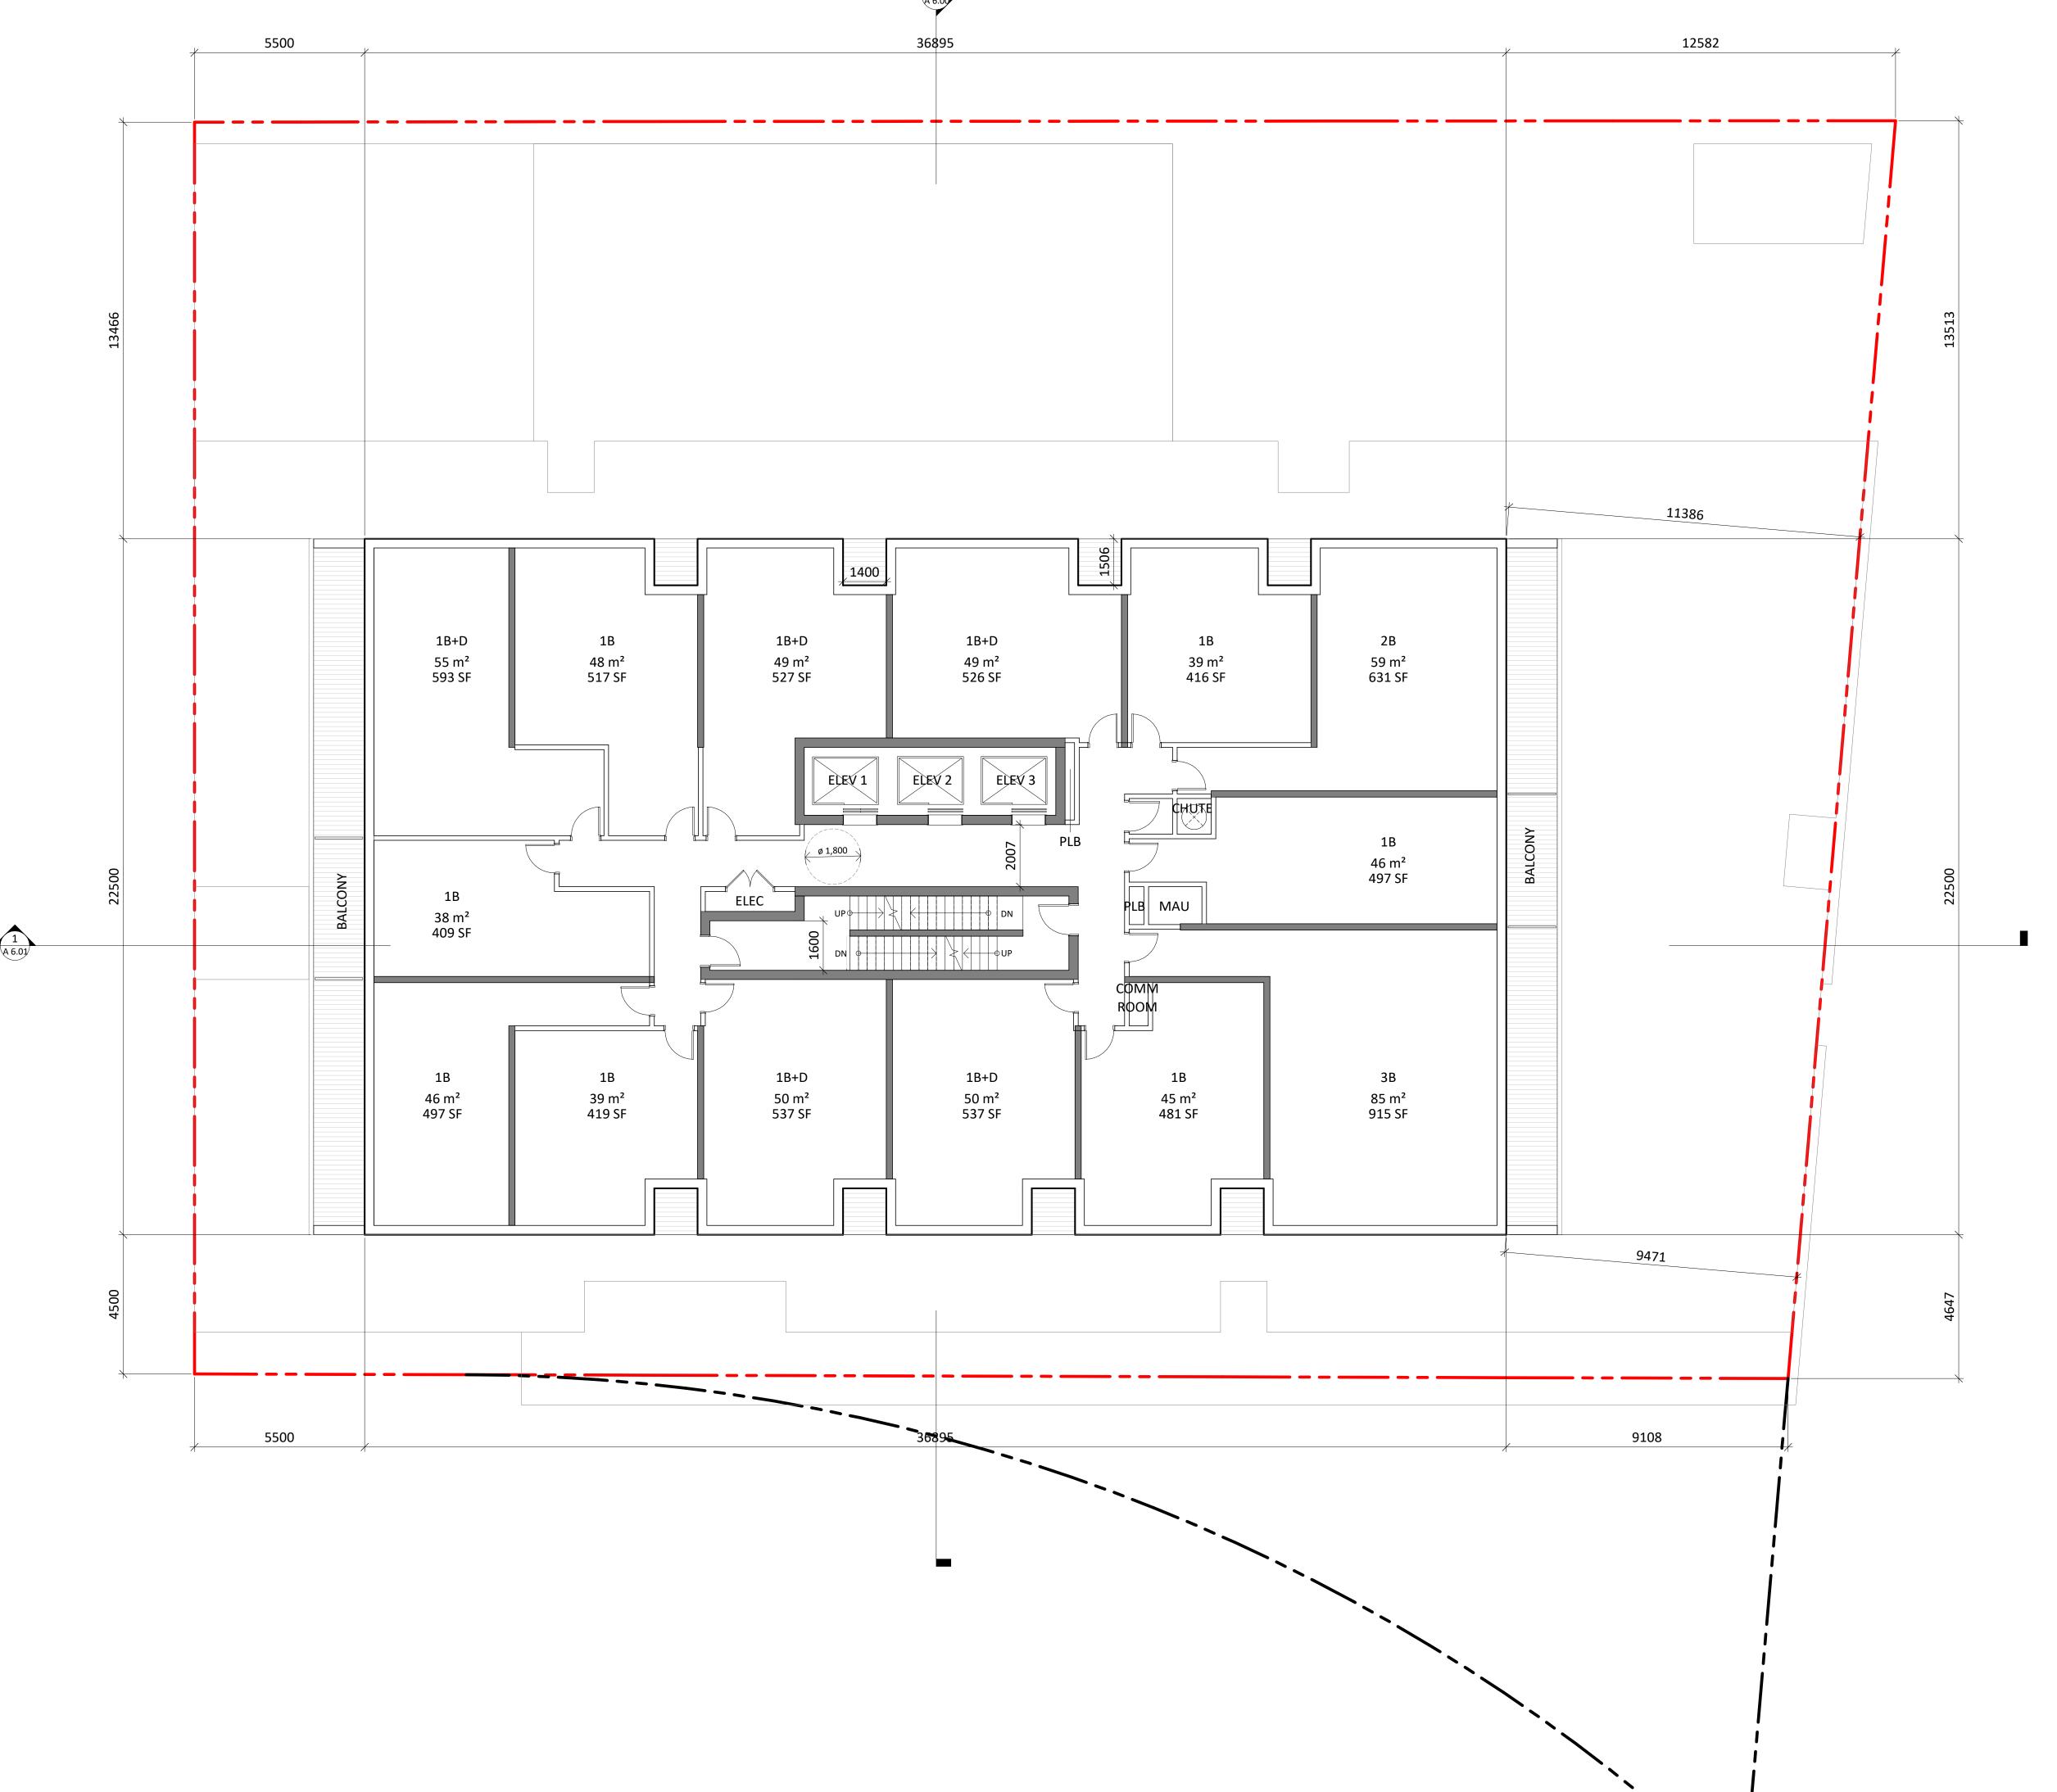
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LEVEL 6 FLOOR PLAN

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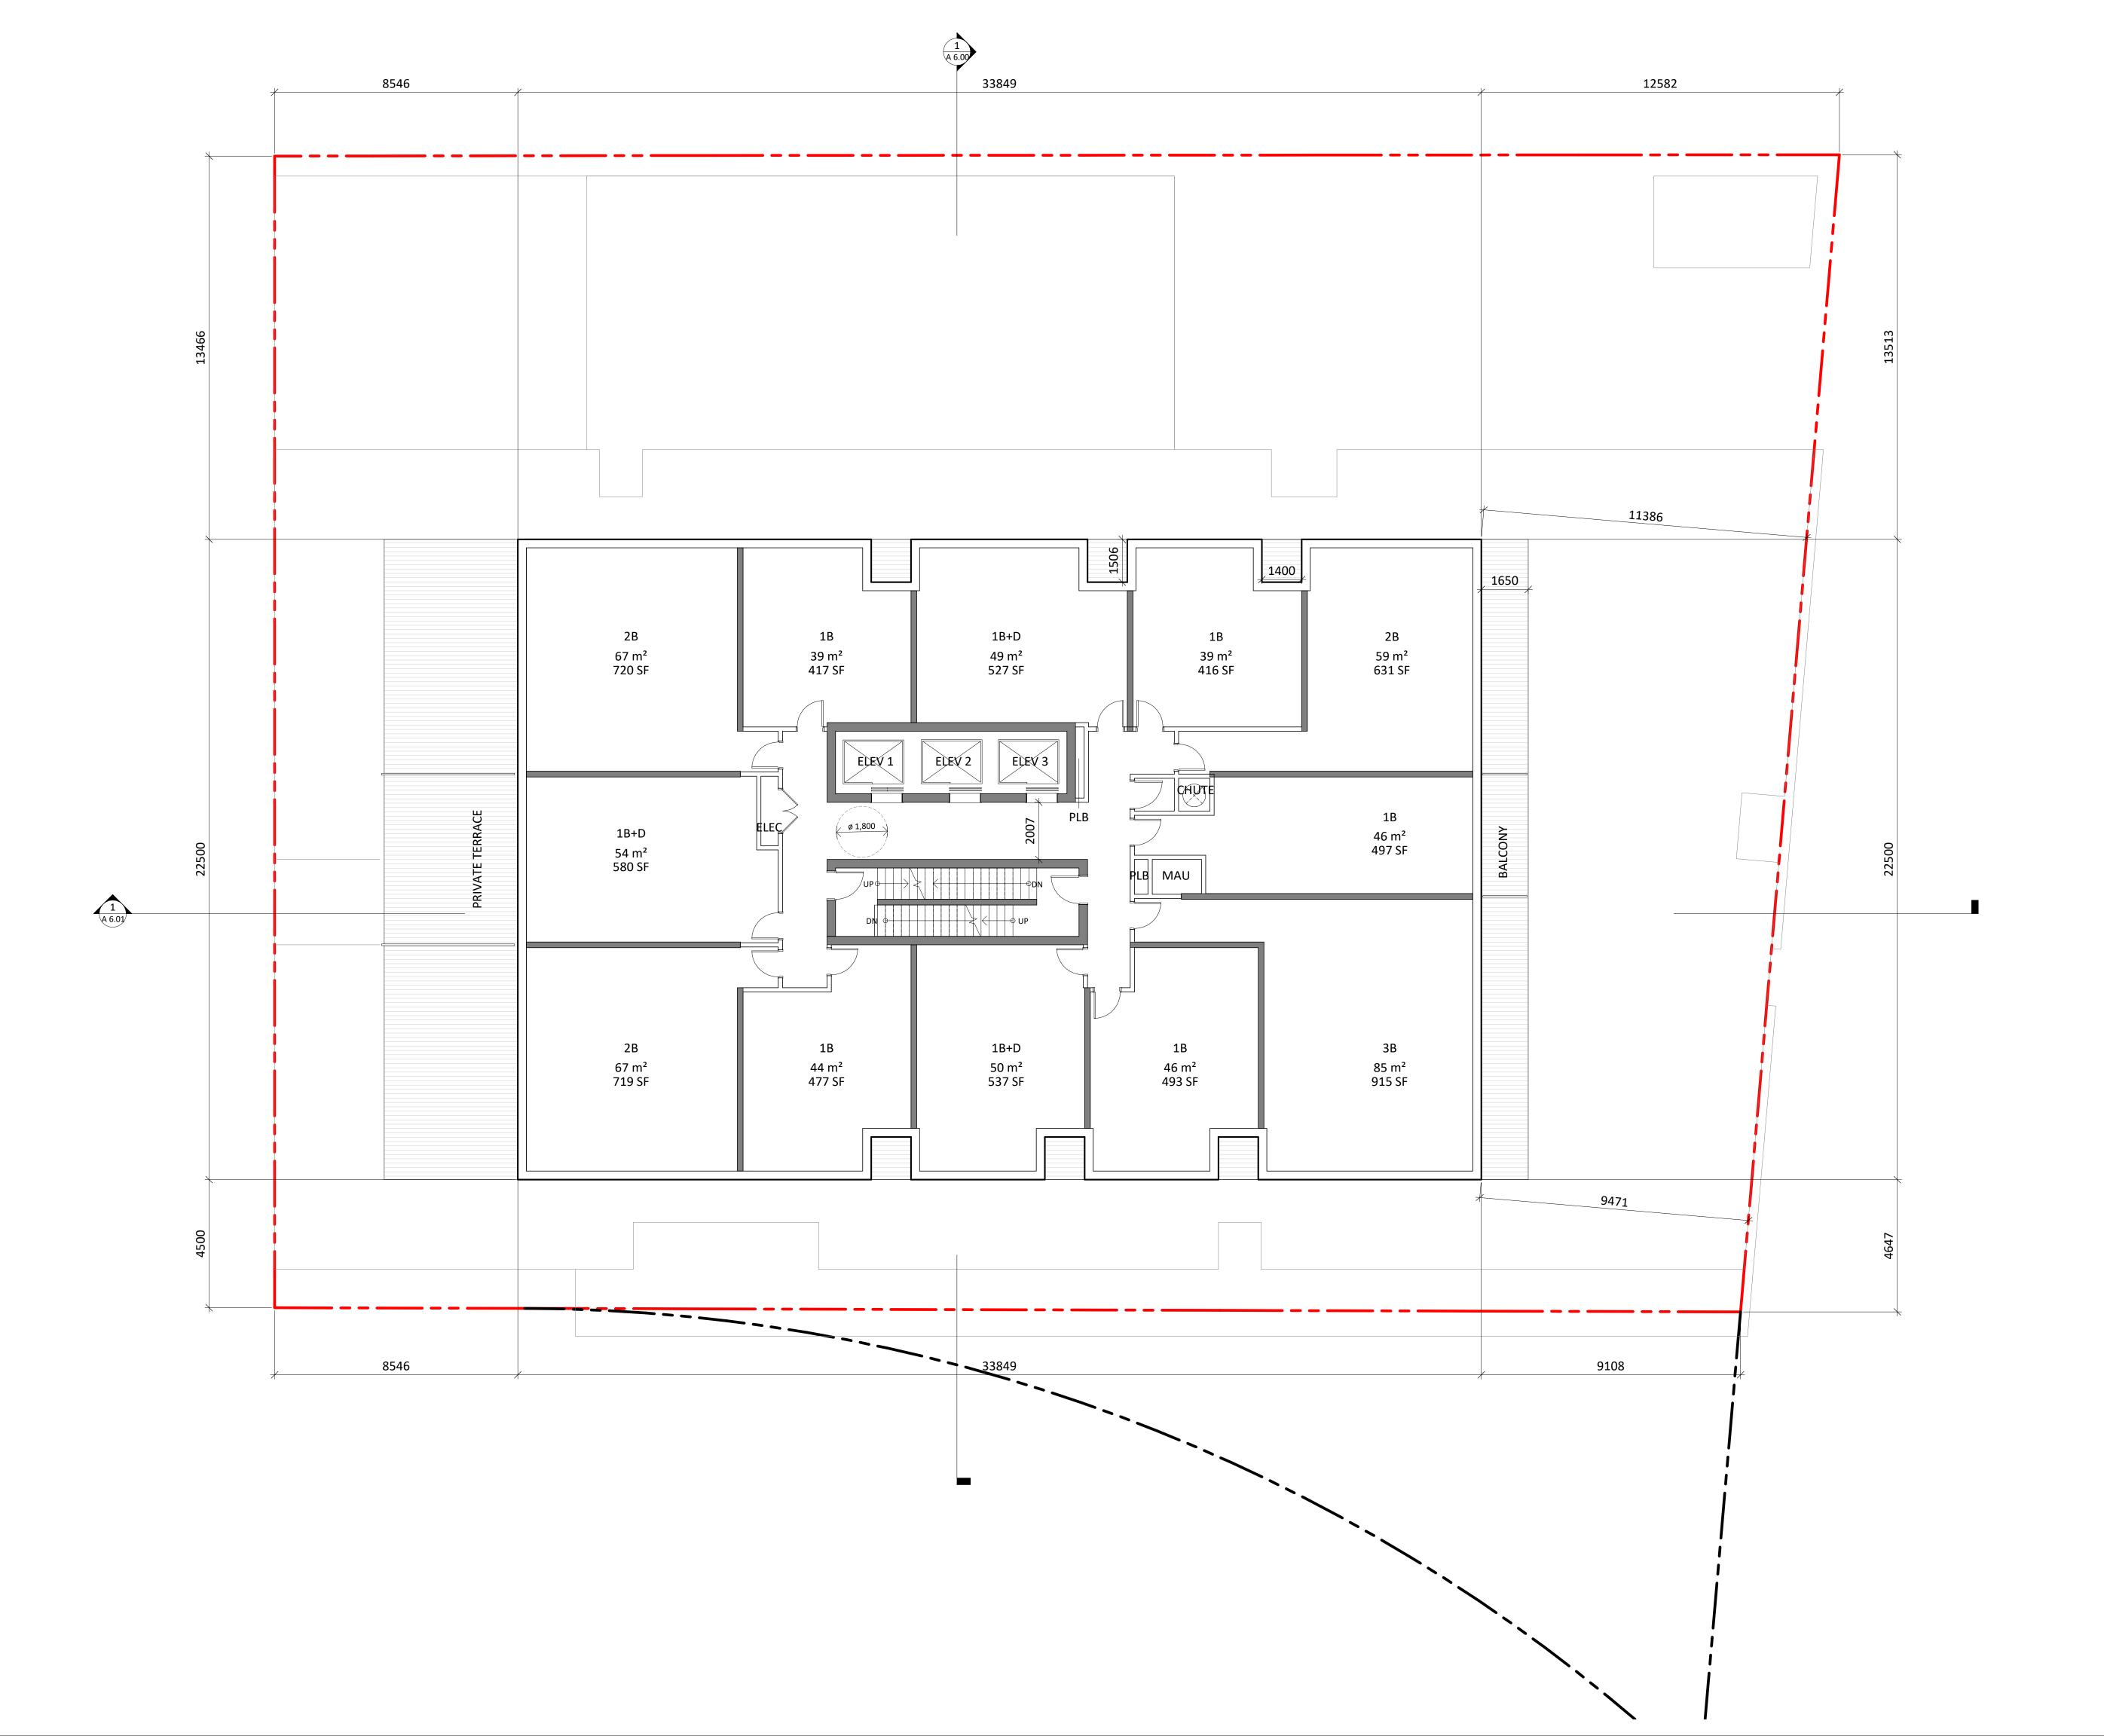
PROPOSED RESIDENTIAL DEVELOPMENT

ADDRESS: 26-38 Hounslow Ave, North York, ON M2N 2A8

LEVEL 7 to 12 FLOOR PLAN

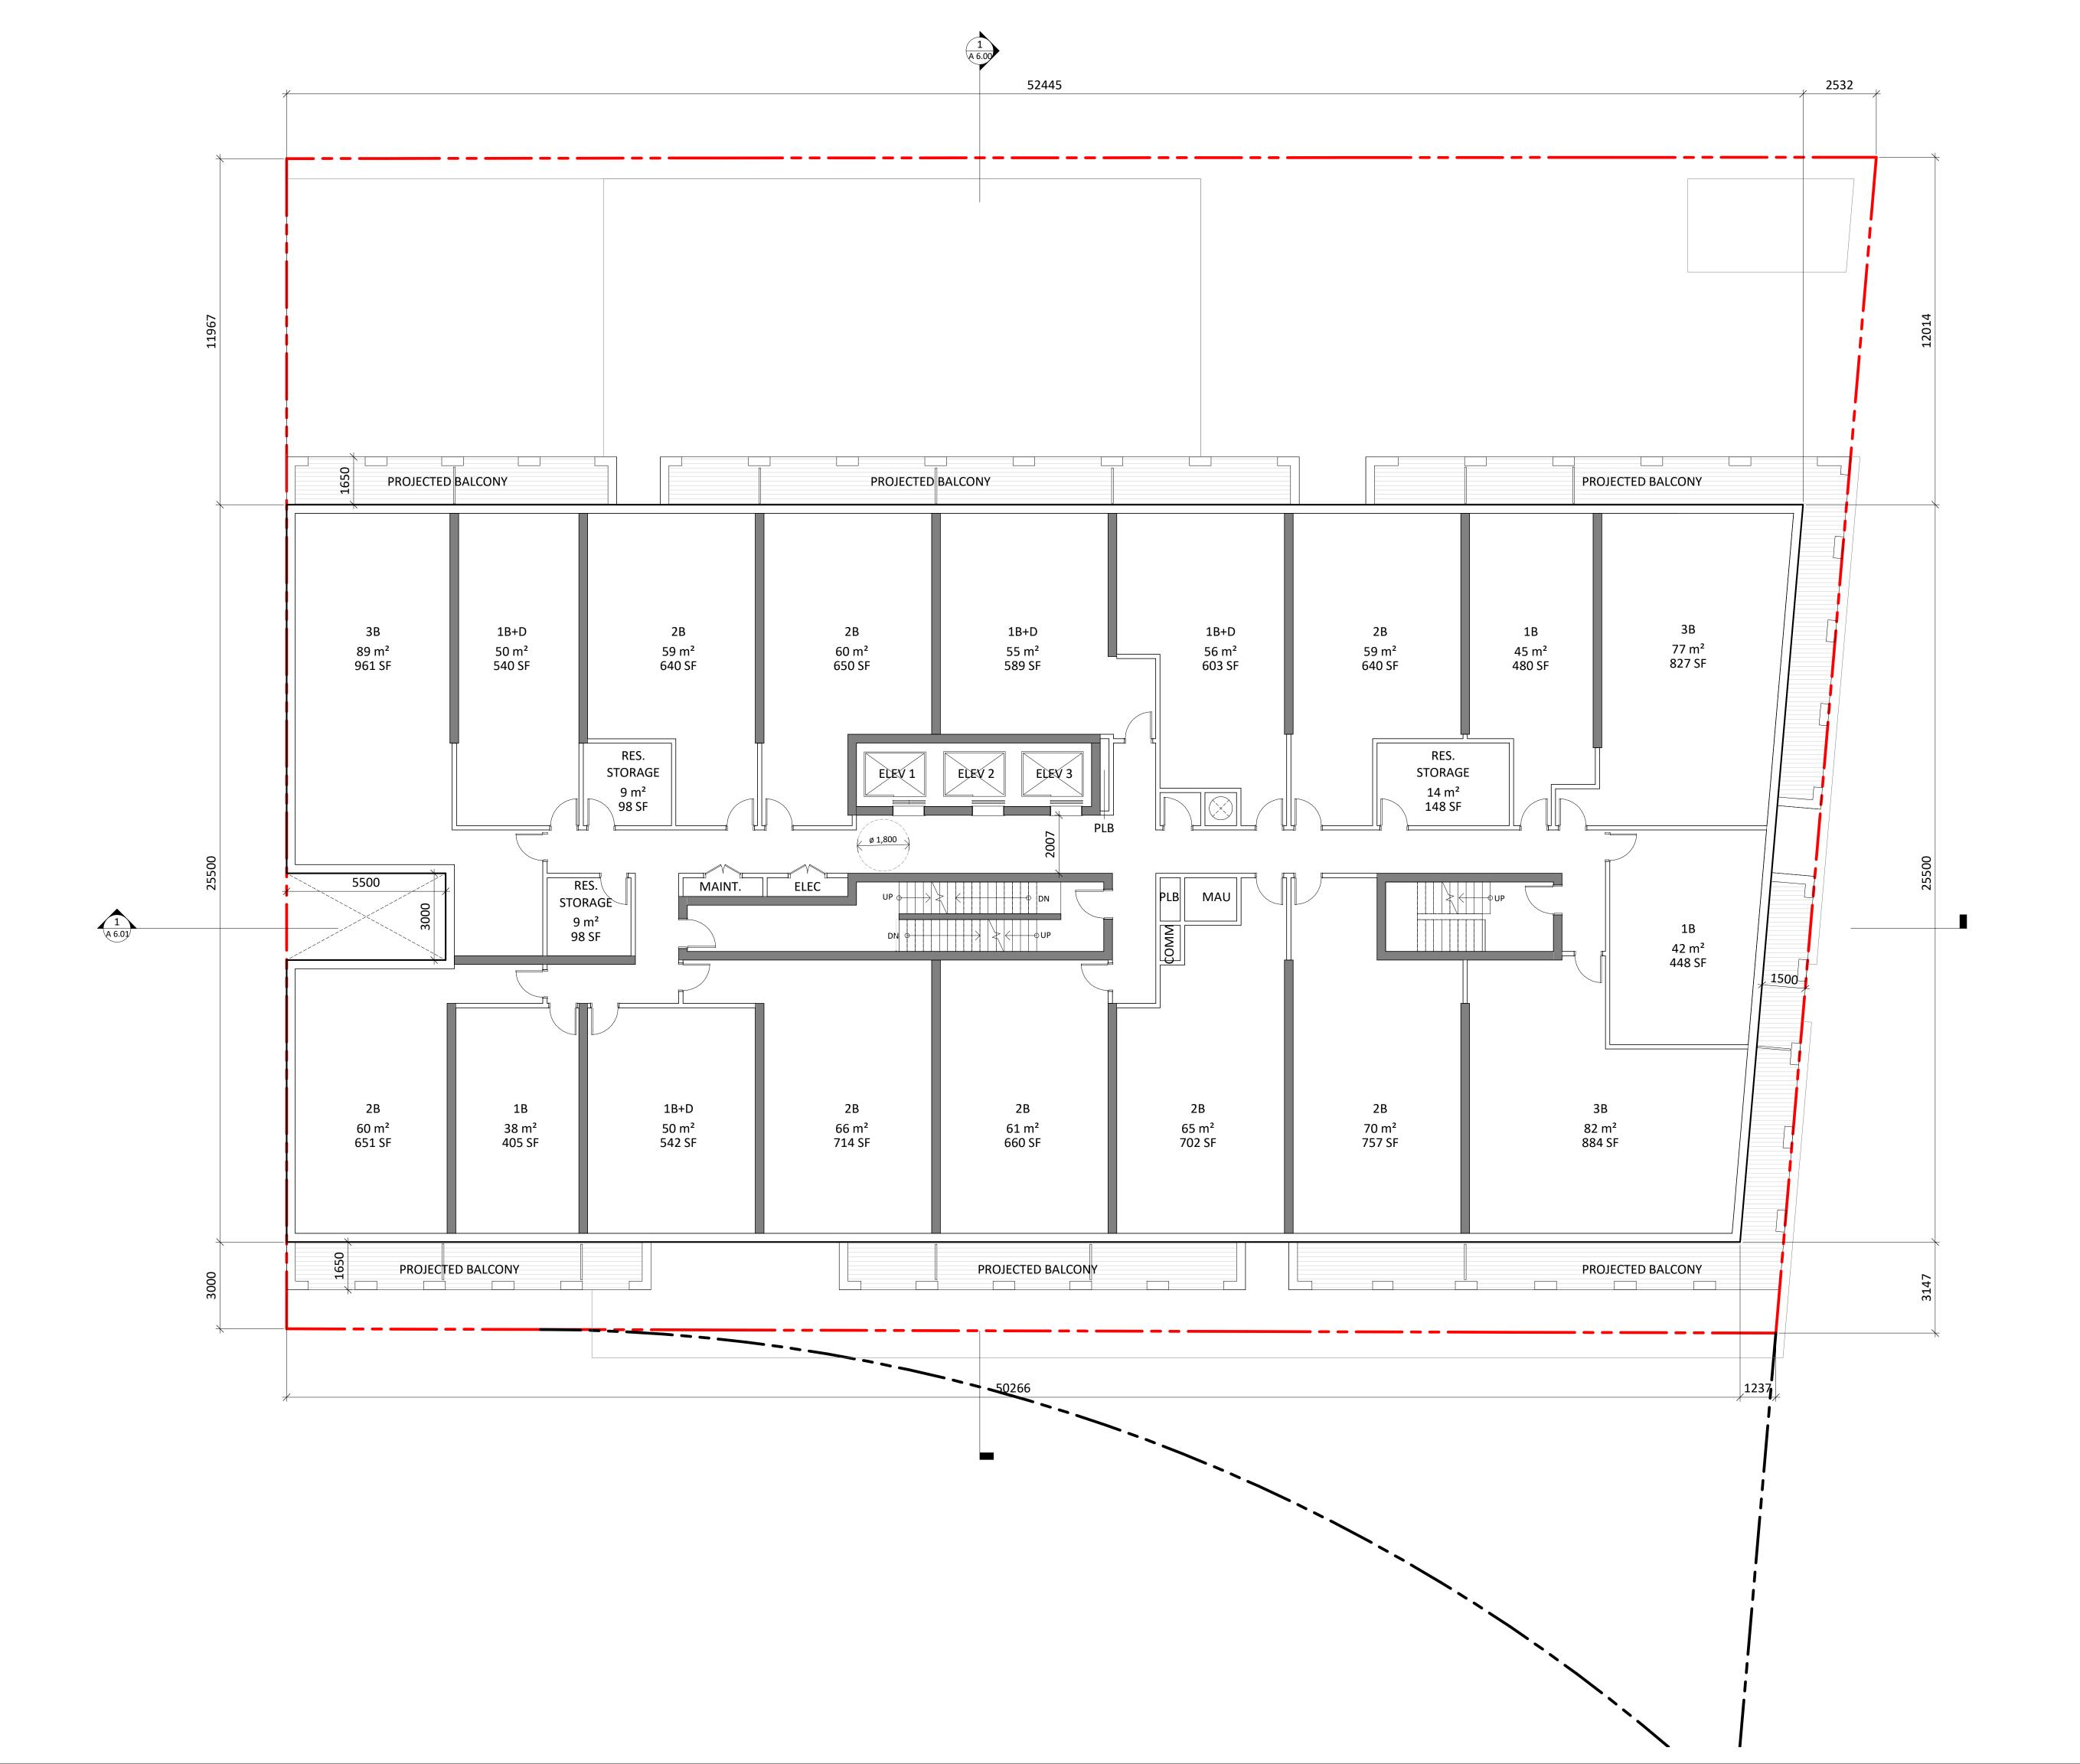Project No.: 2224
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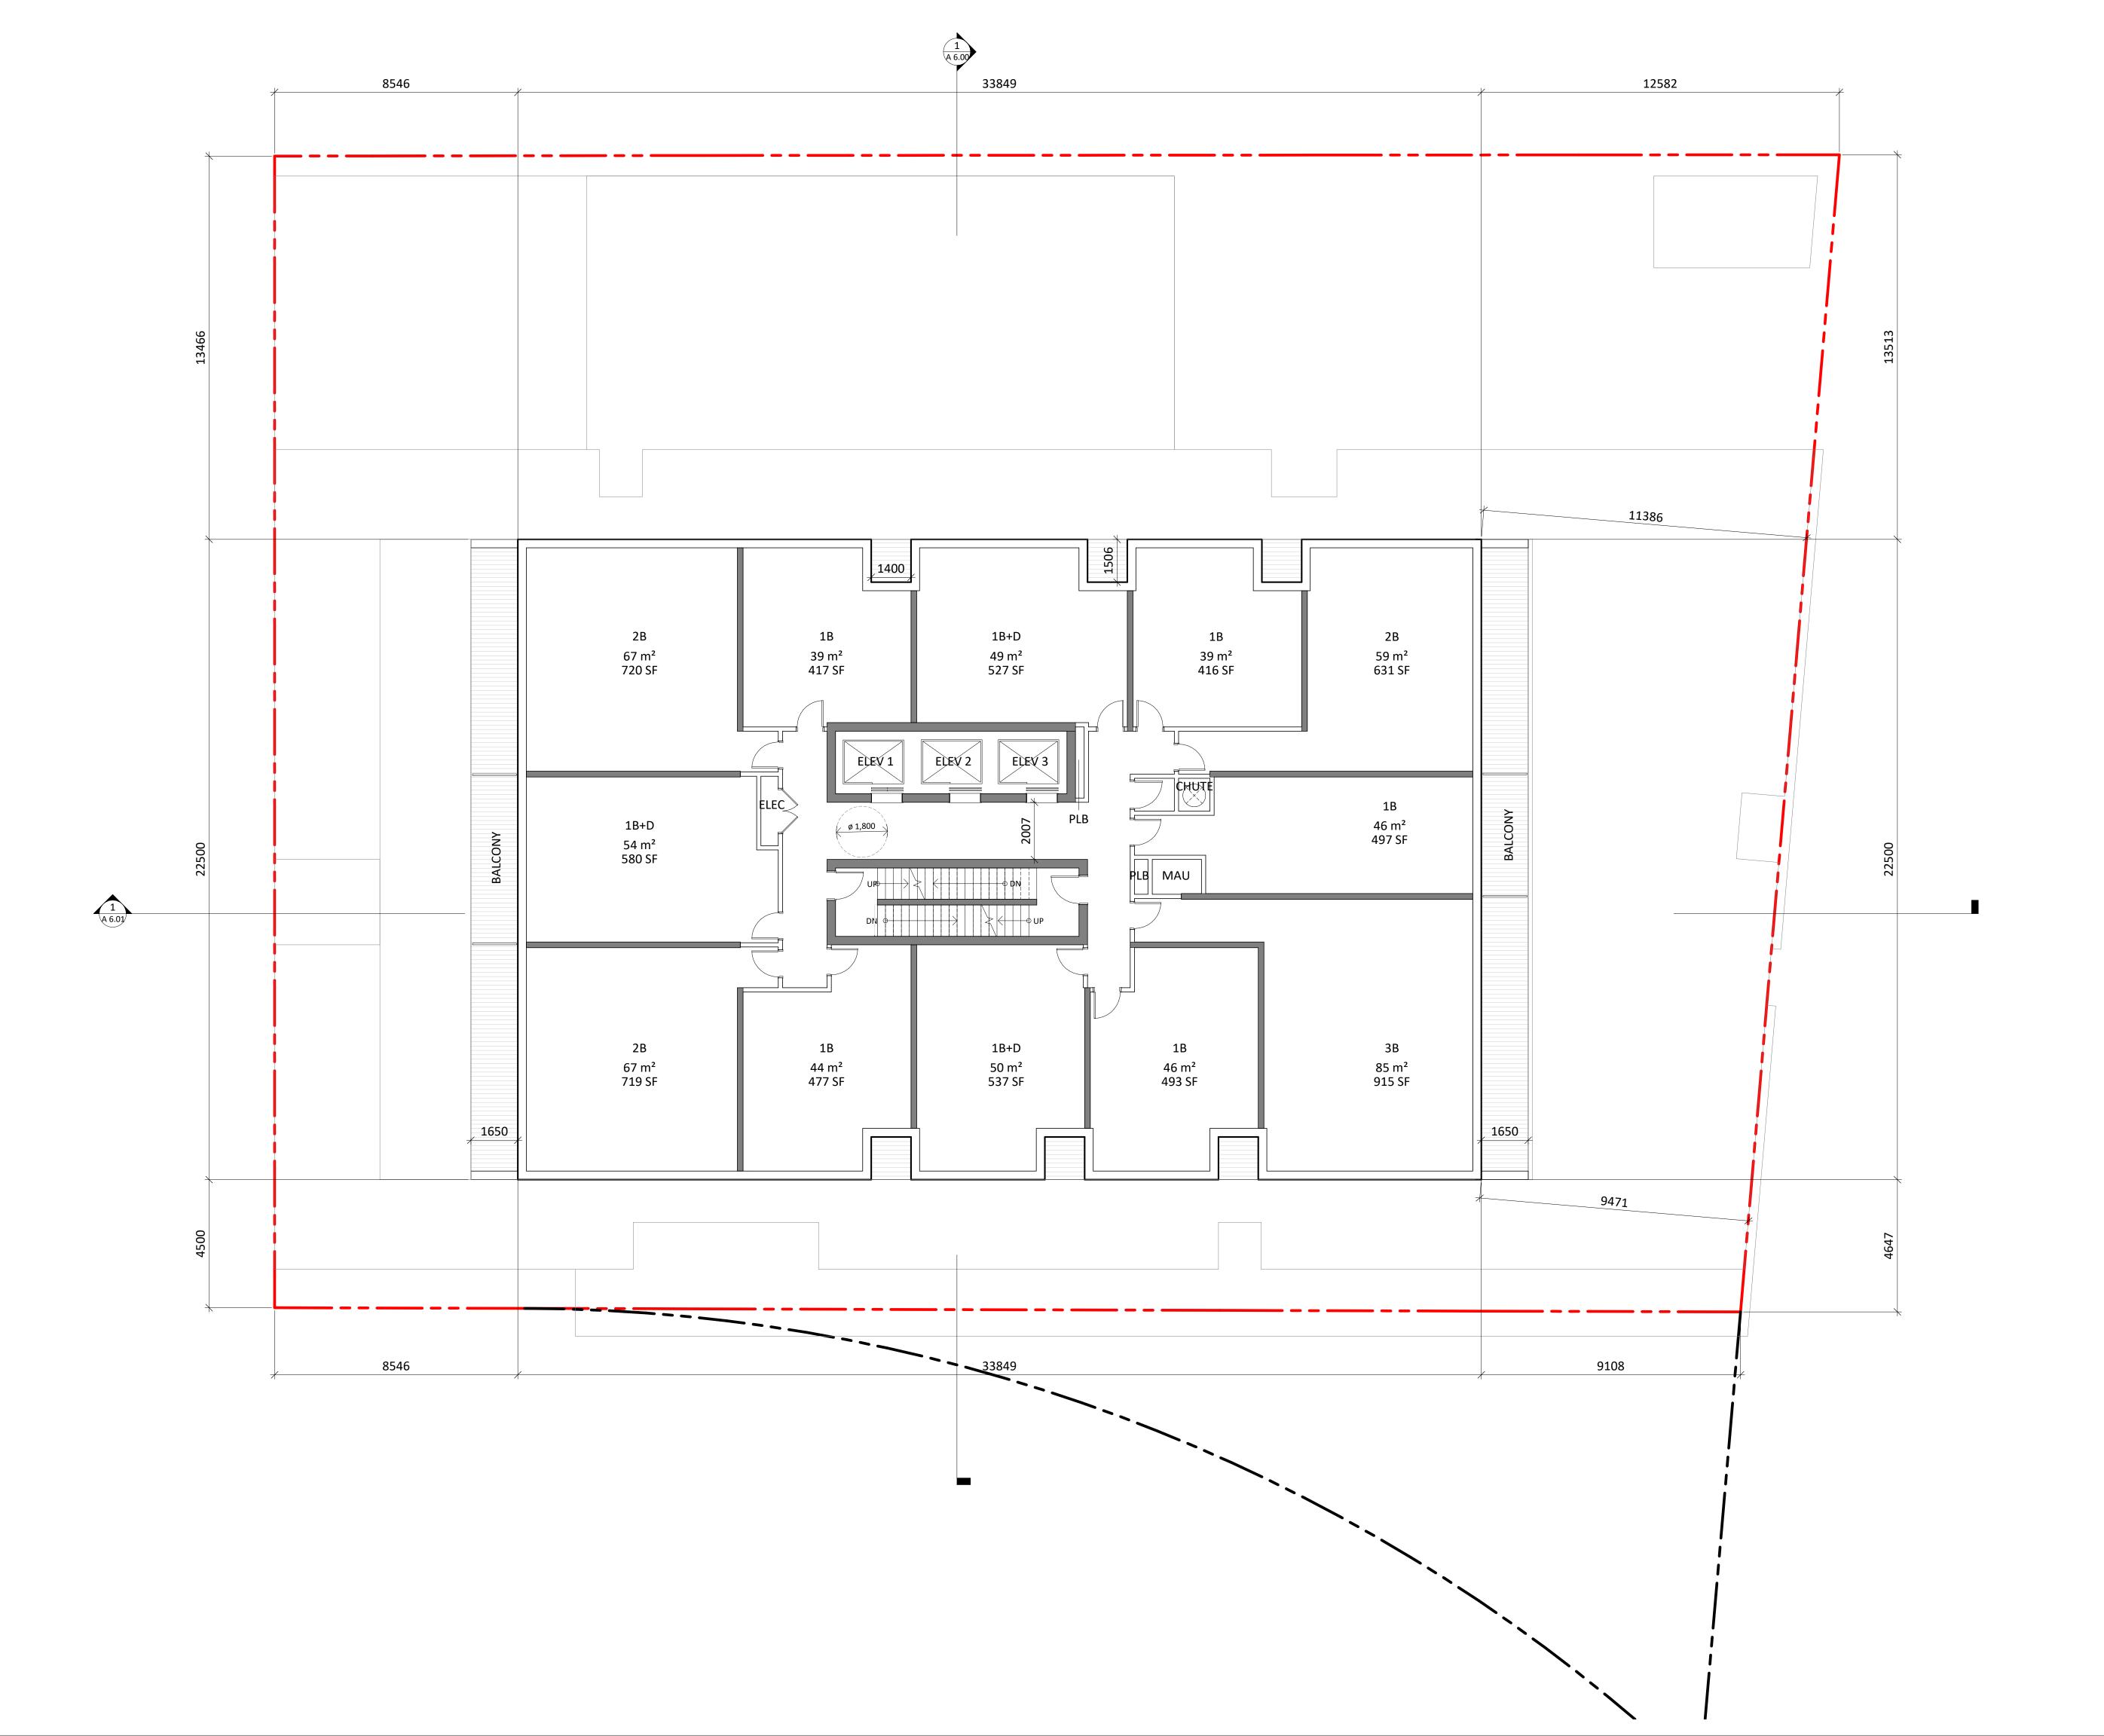
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LEVEL 13 FLOOR

PLAN

Project No.: 2224
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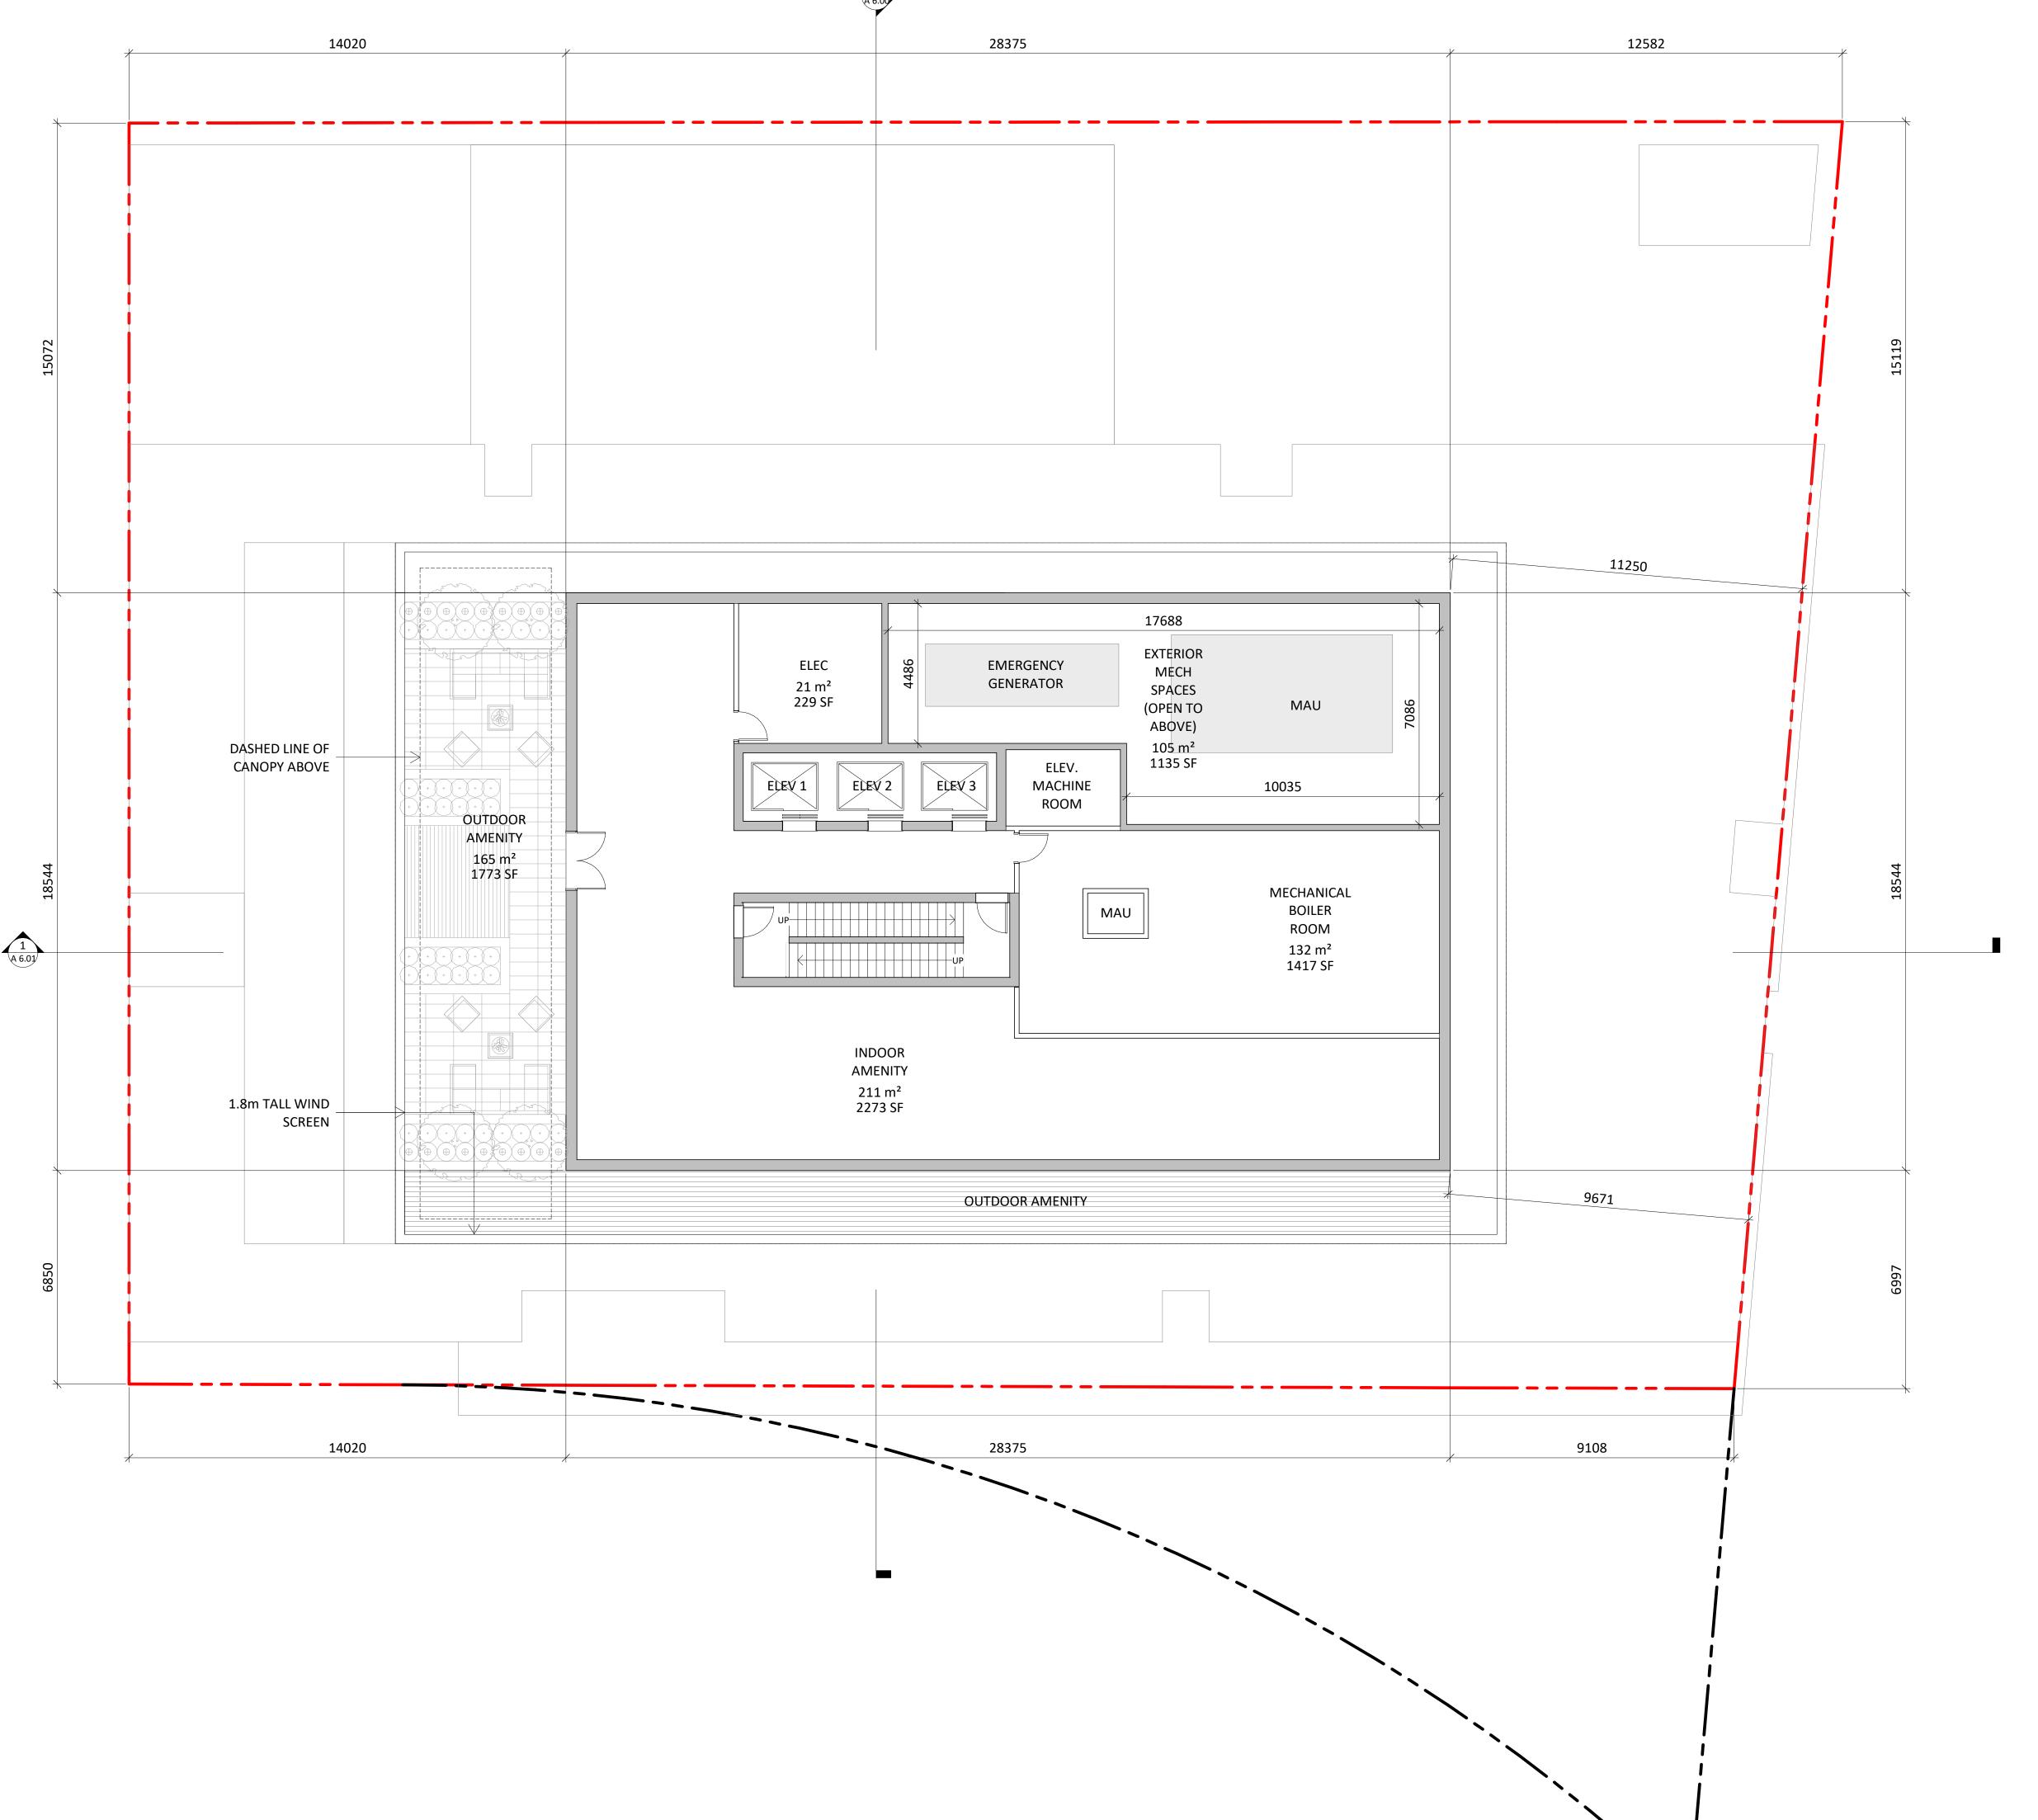
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LEVEL 14 to 24 FLOOR PLAN

Project No.: 2224
Scale: 1:100
Date: SEPTEMBER 29, 2023
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Drawing No.:





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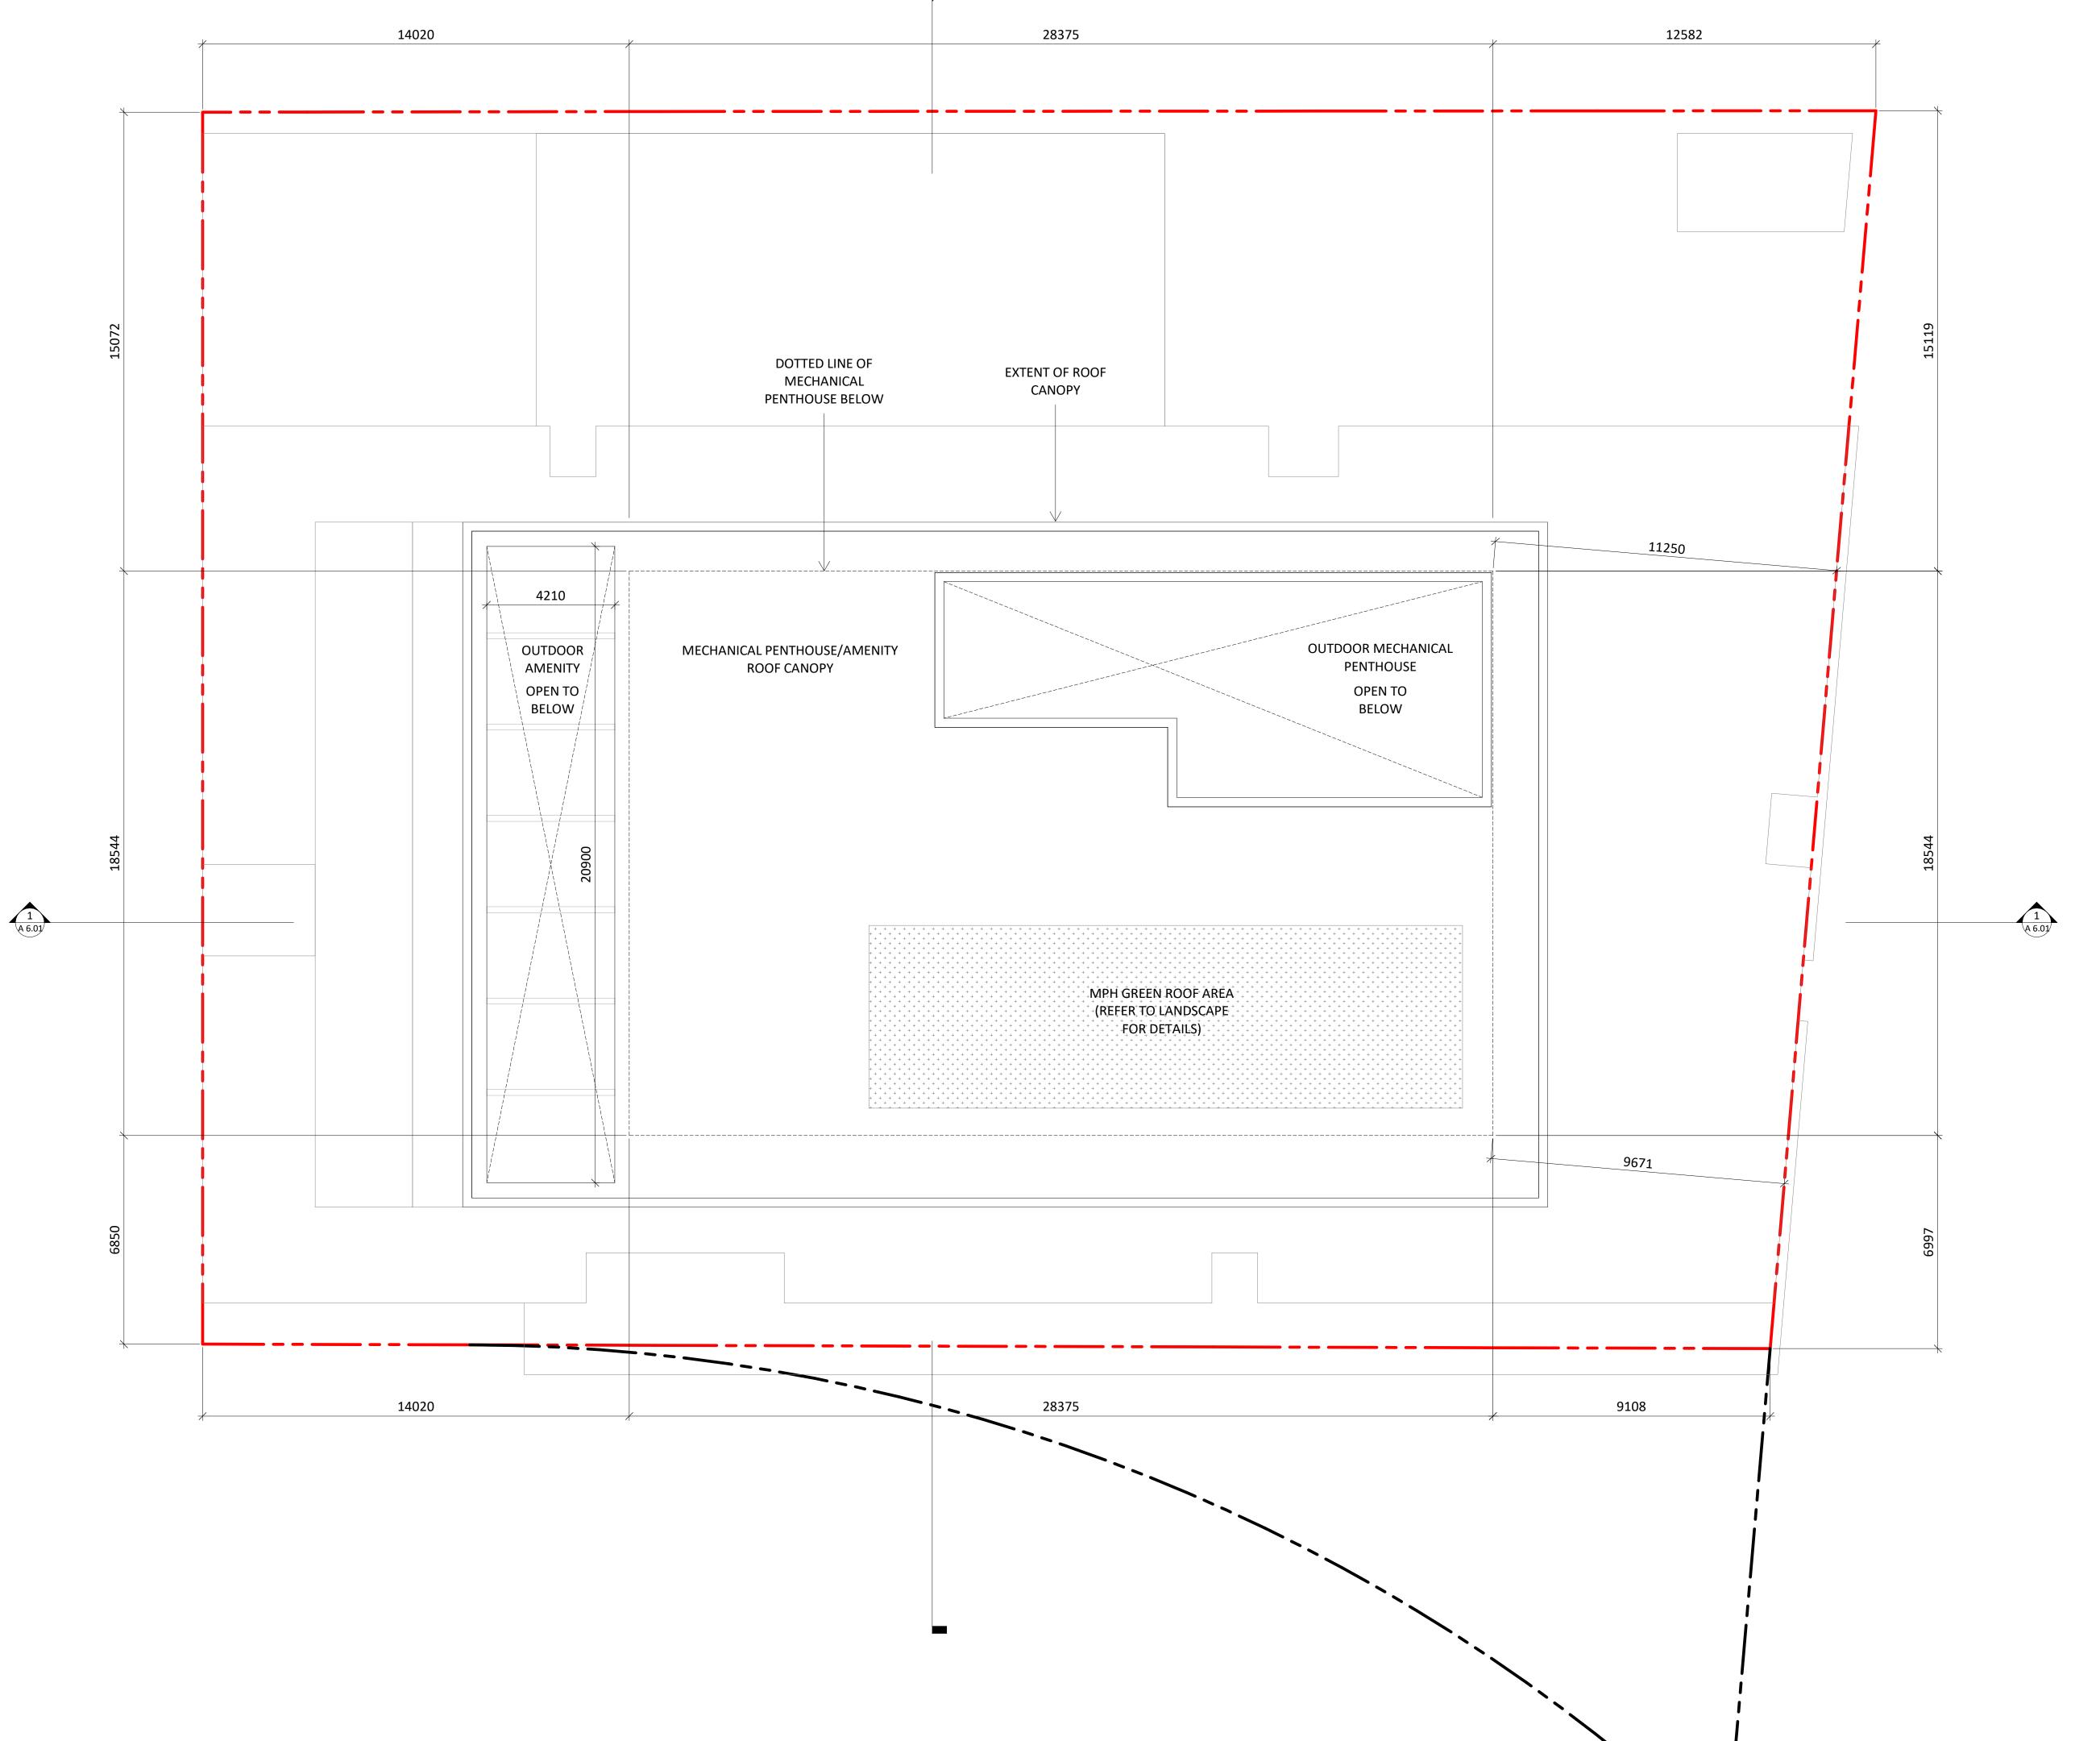
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MECH/AMENITY

Project No.: 2224
Scale: 1:100
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Drawing No.





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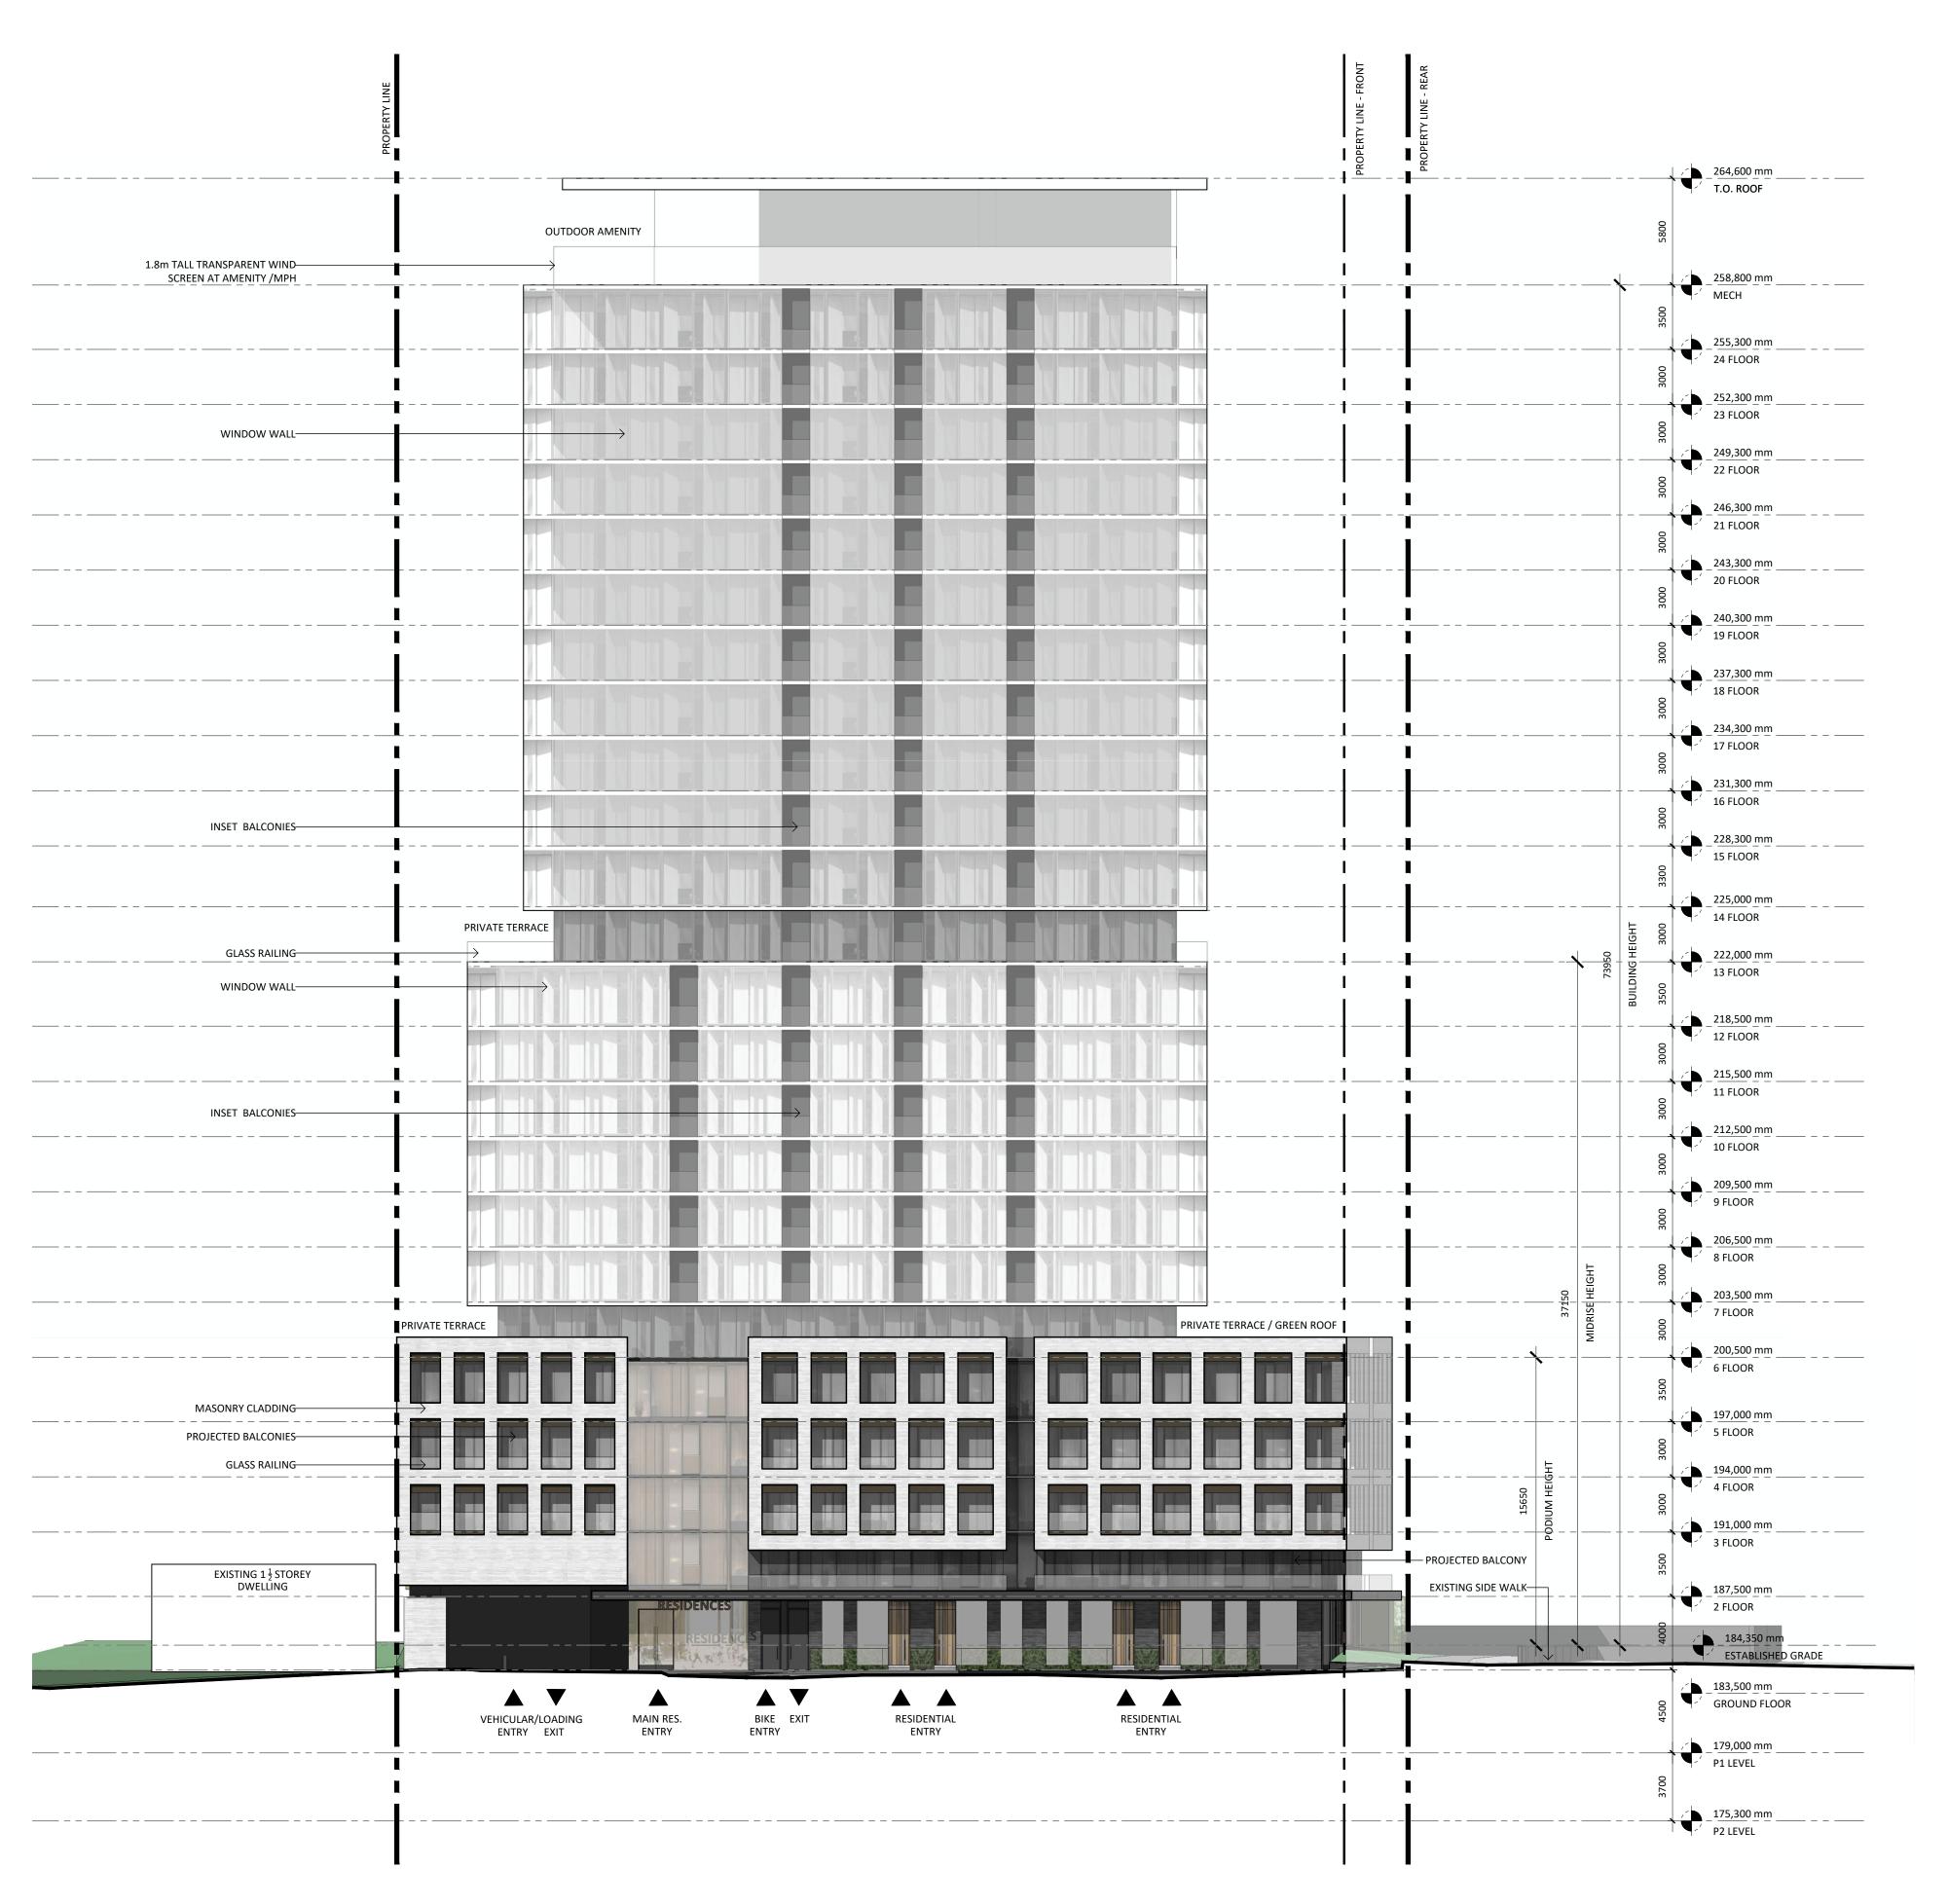
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ROOF PLAN

Project No.: 2224
Scale: 1:100
Date: SEPTEMBER 29, 2023
Drawn by: STUDIO JCI

Drawing No.:



ESTABLISHED GRADE IS CALCULATED AS AVERAGE ELEVATION OF THE GROUND ALONG ALL LOT LINES THAT ABUT A STREET (HOUNSLOW) AT PROPERTY LINE.

AVERAGE OF 184.15 and 184.55 = 184.35

REFER TO CIVIL DRAWING FOR DETAILED SITE GRADING

BUILDING HEIGHT

THE HEIGHT OF A BUILDING IS THE DISTANCE BETWEEN THE ESTABLISHED GRADE AND THE ELEVATION OF THE HIGHEST POINT OF THE BUILDING (ZONING BY-LAW 569-2013).

Issued:

Rev. Issuance

General Notes:

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2. Drawings are not to be scaled for construction. Contractor to verify all existing conditions and dimensions required to perform the Work and report any discrepancies with the Contract Documents to the Architect before commencing work.

3. Positions of exposed or finished mechanical or electrical devices, fittings, and fixtures are indicated on the Architectural drawings. The locations shown on the Architectural drawings govern over the Mechanical and Electrical drawings. Those items not clearly located will be located as directed by the Architect

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STUDIO**JCI**

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PROPOSED RESIDENTIAL DEVELOPMENT

ADDRESS: 26-28 Hounslow Ave, North York, ON M2N 2A8


SOUTH ELEVATION

Project No.: 2224
Scale: 1 : 200
Date: SEPTEMBER 29, 2023

Drawn by: STUDIO JCI

Drawing No.:

A 5.00

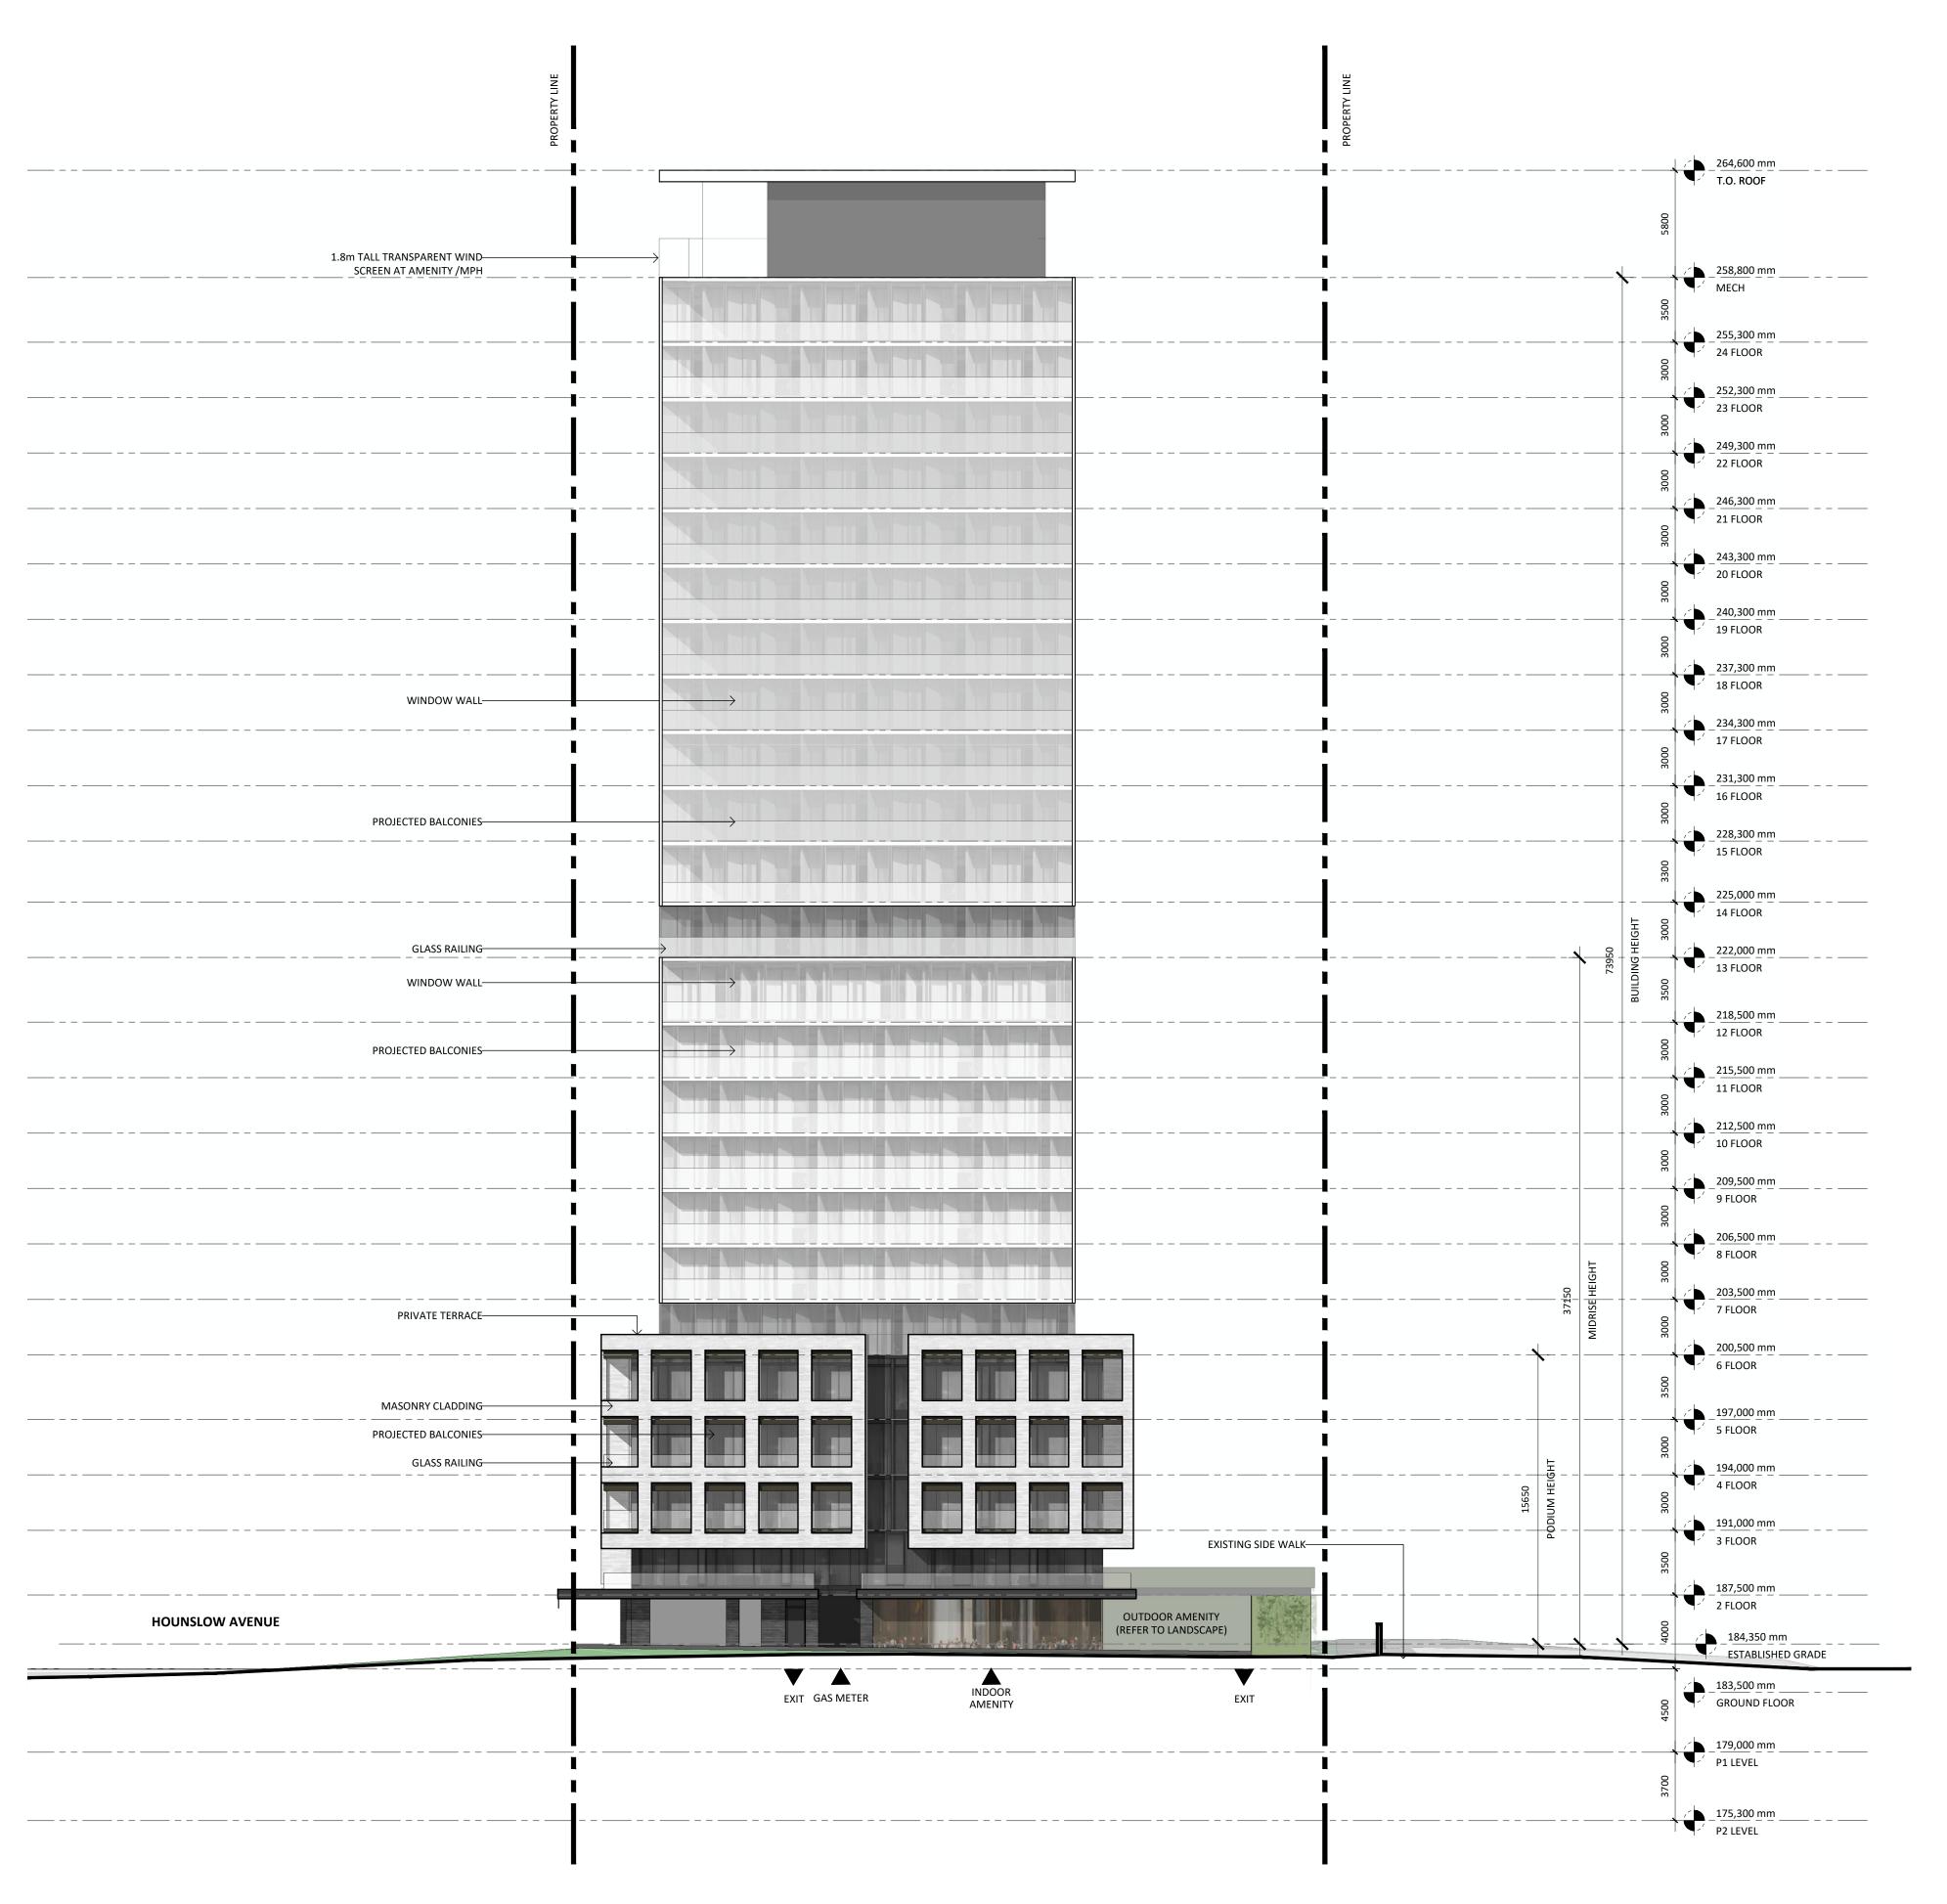

ESTABLISHED GRADE IS CALCULATED AS AVERAGE ELEVATION OF THE GROUND ALONG ALL LOT LINES THAT ABUT A STREET (HOUNSLOW) AT PROPERTY LINE.

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OPA/ZBASep. 29, 2023Rev. IssuanceDate

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ADDRESS:

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EAST ELEVATION

Project No.: 2224


Scale: 1 : 200

Date: SEPTEMBER 29, 2023

Drawn by: STUDIO JCI

Drawing No.:

A 5.01

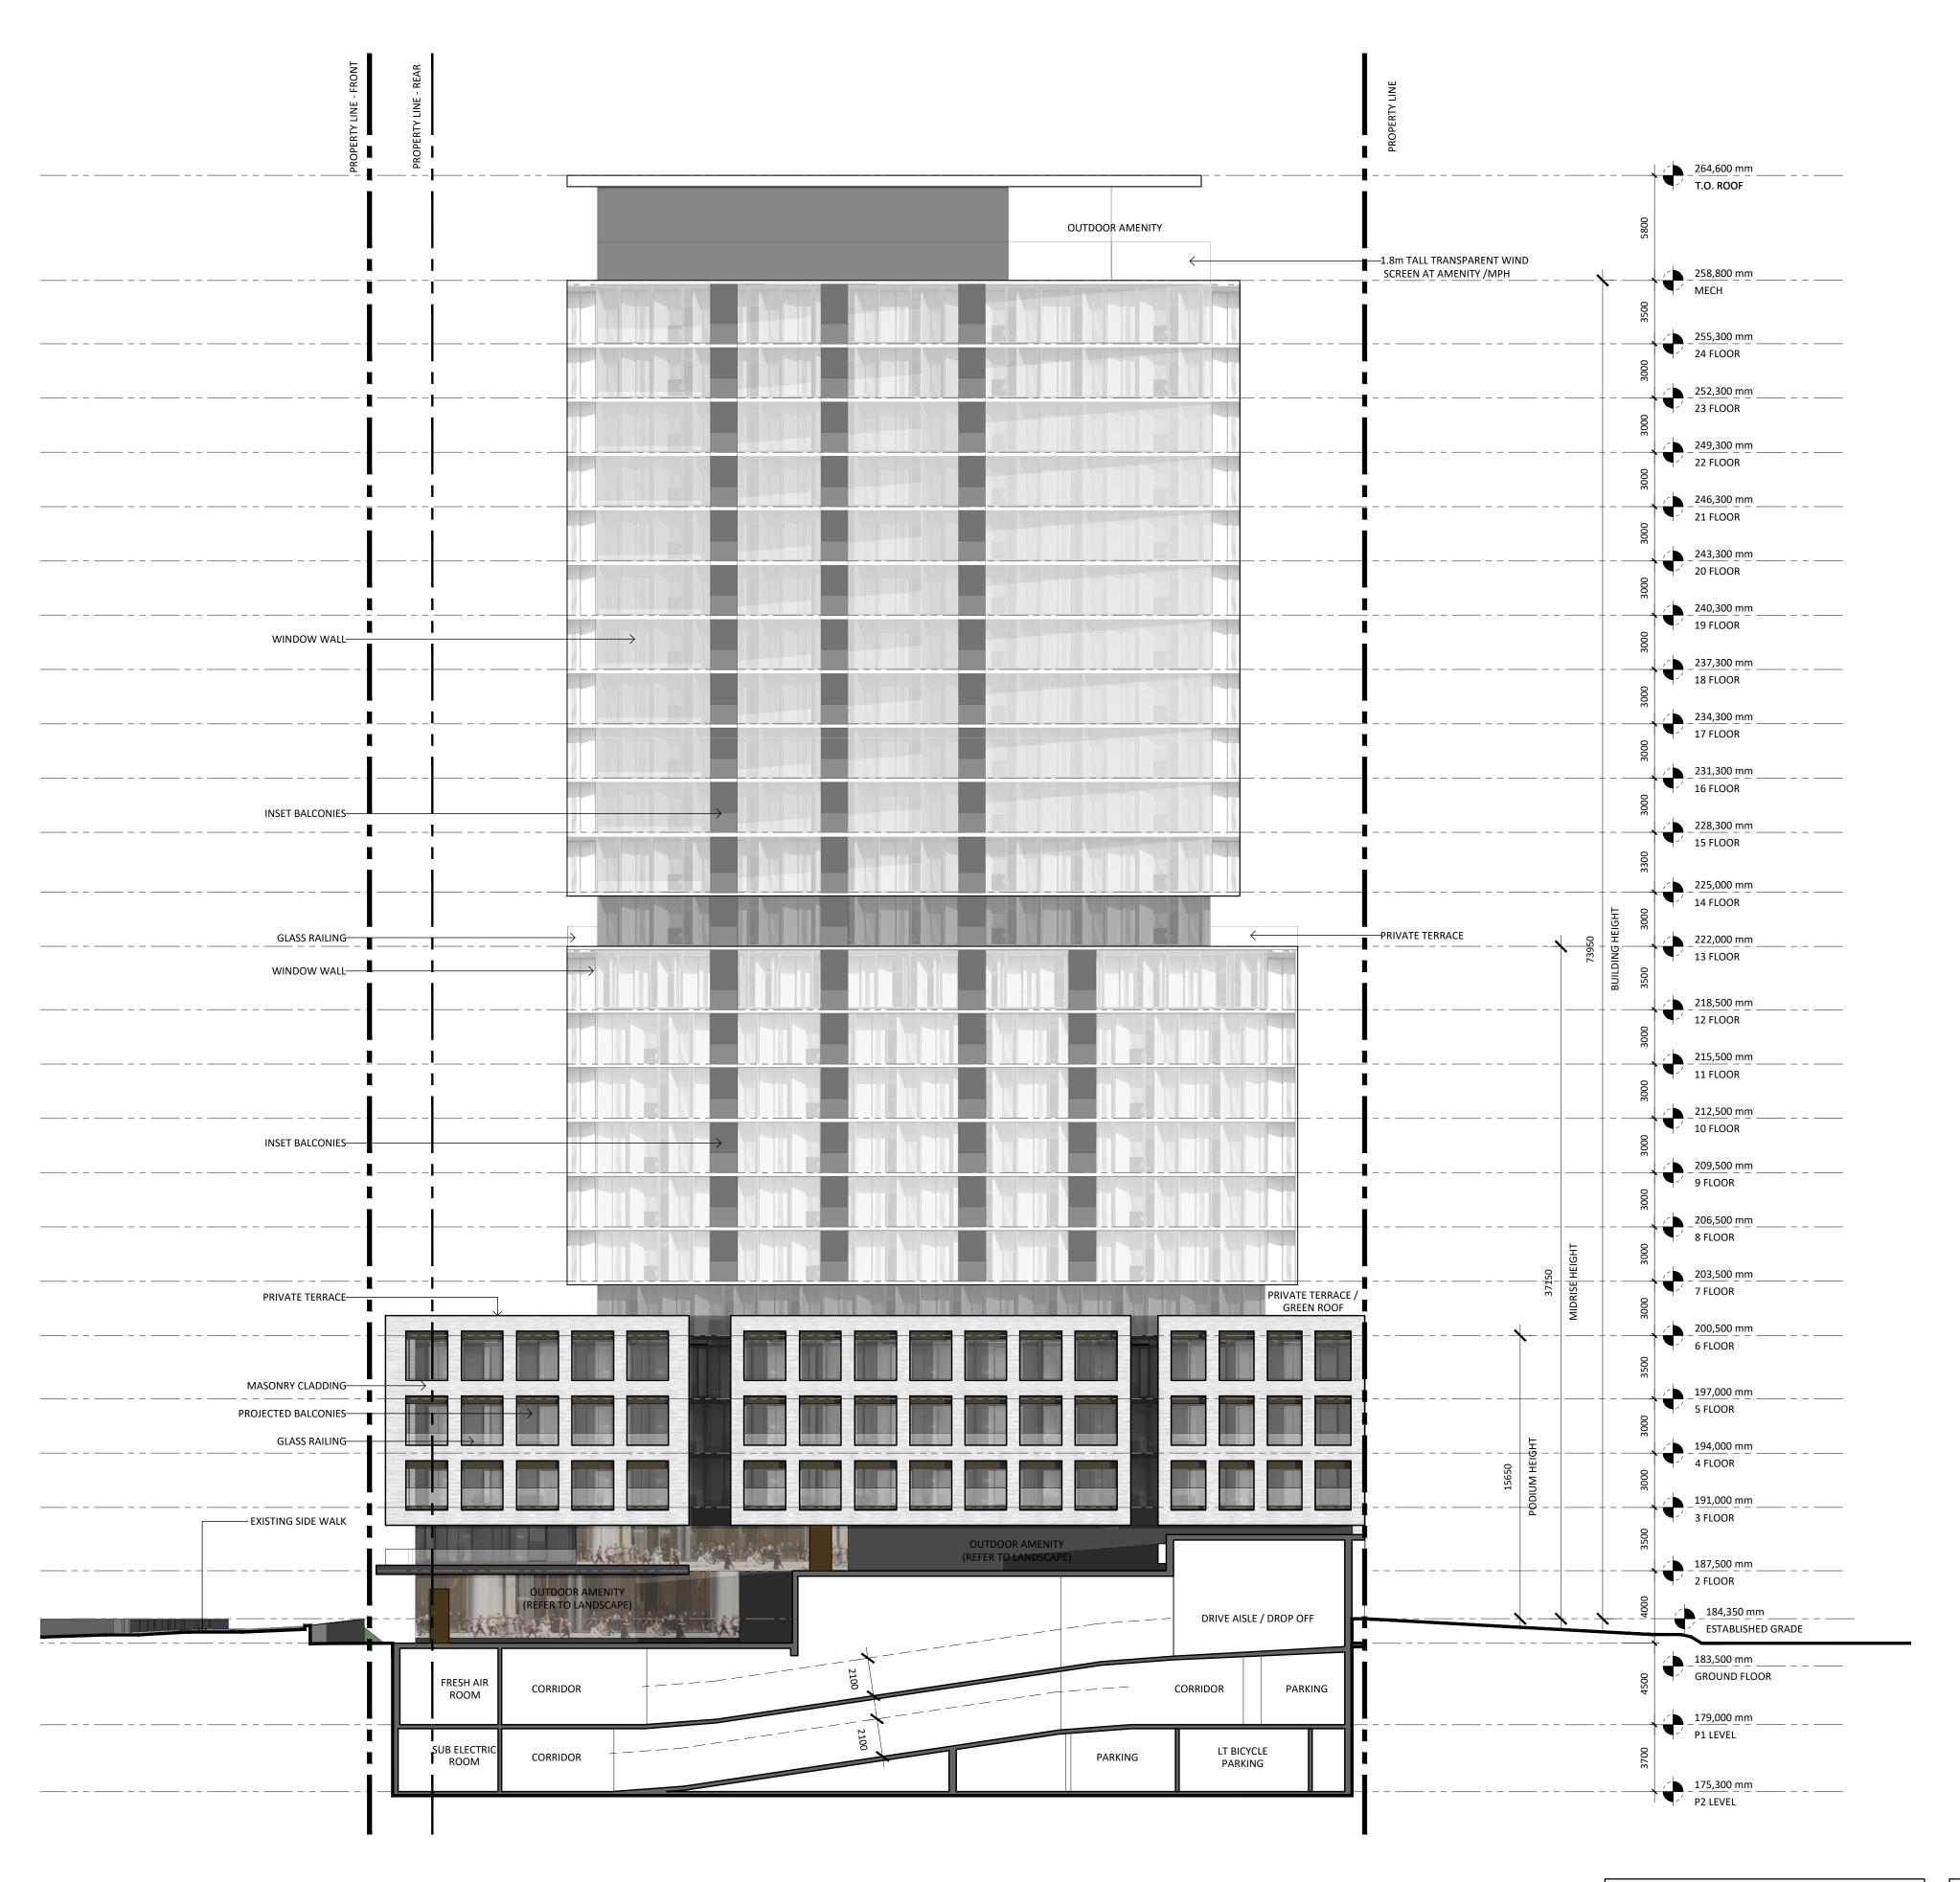

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PROPOSED RESIDENTIAL DEVELOPMENT

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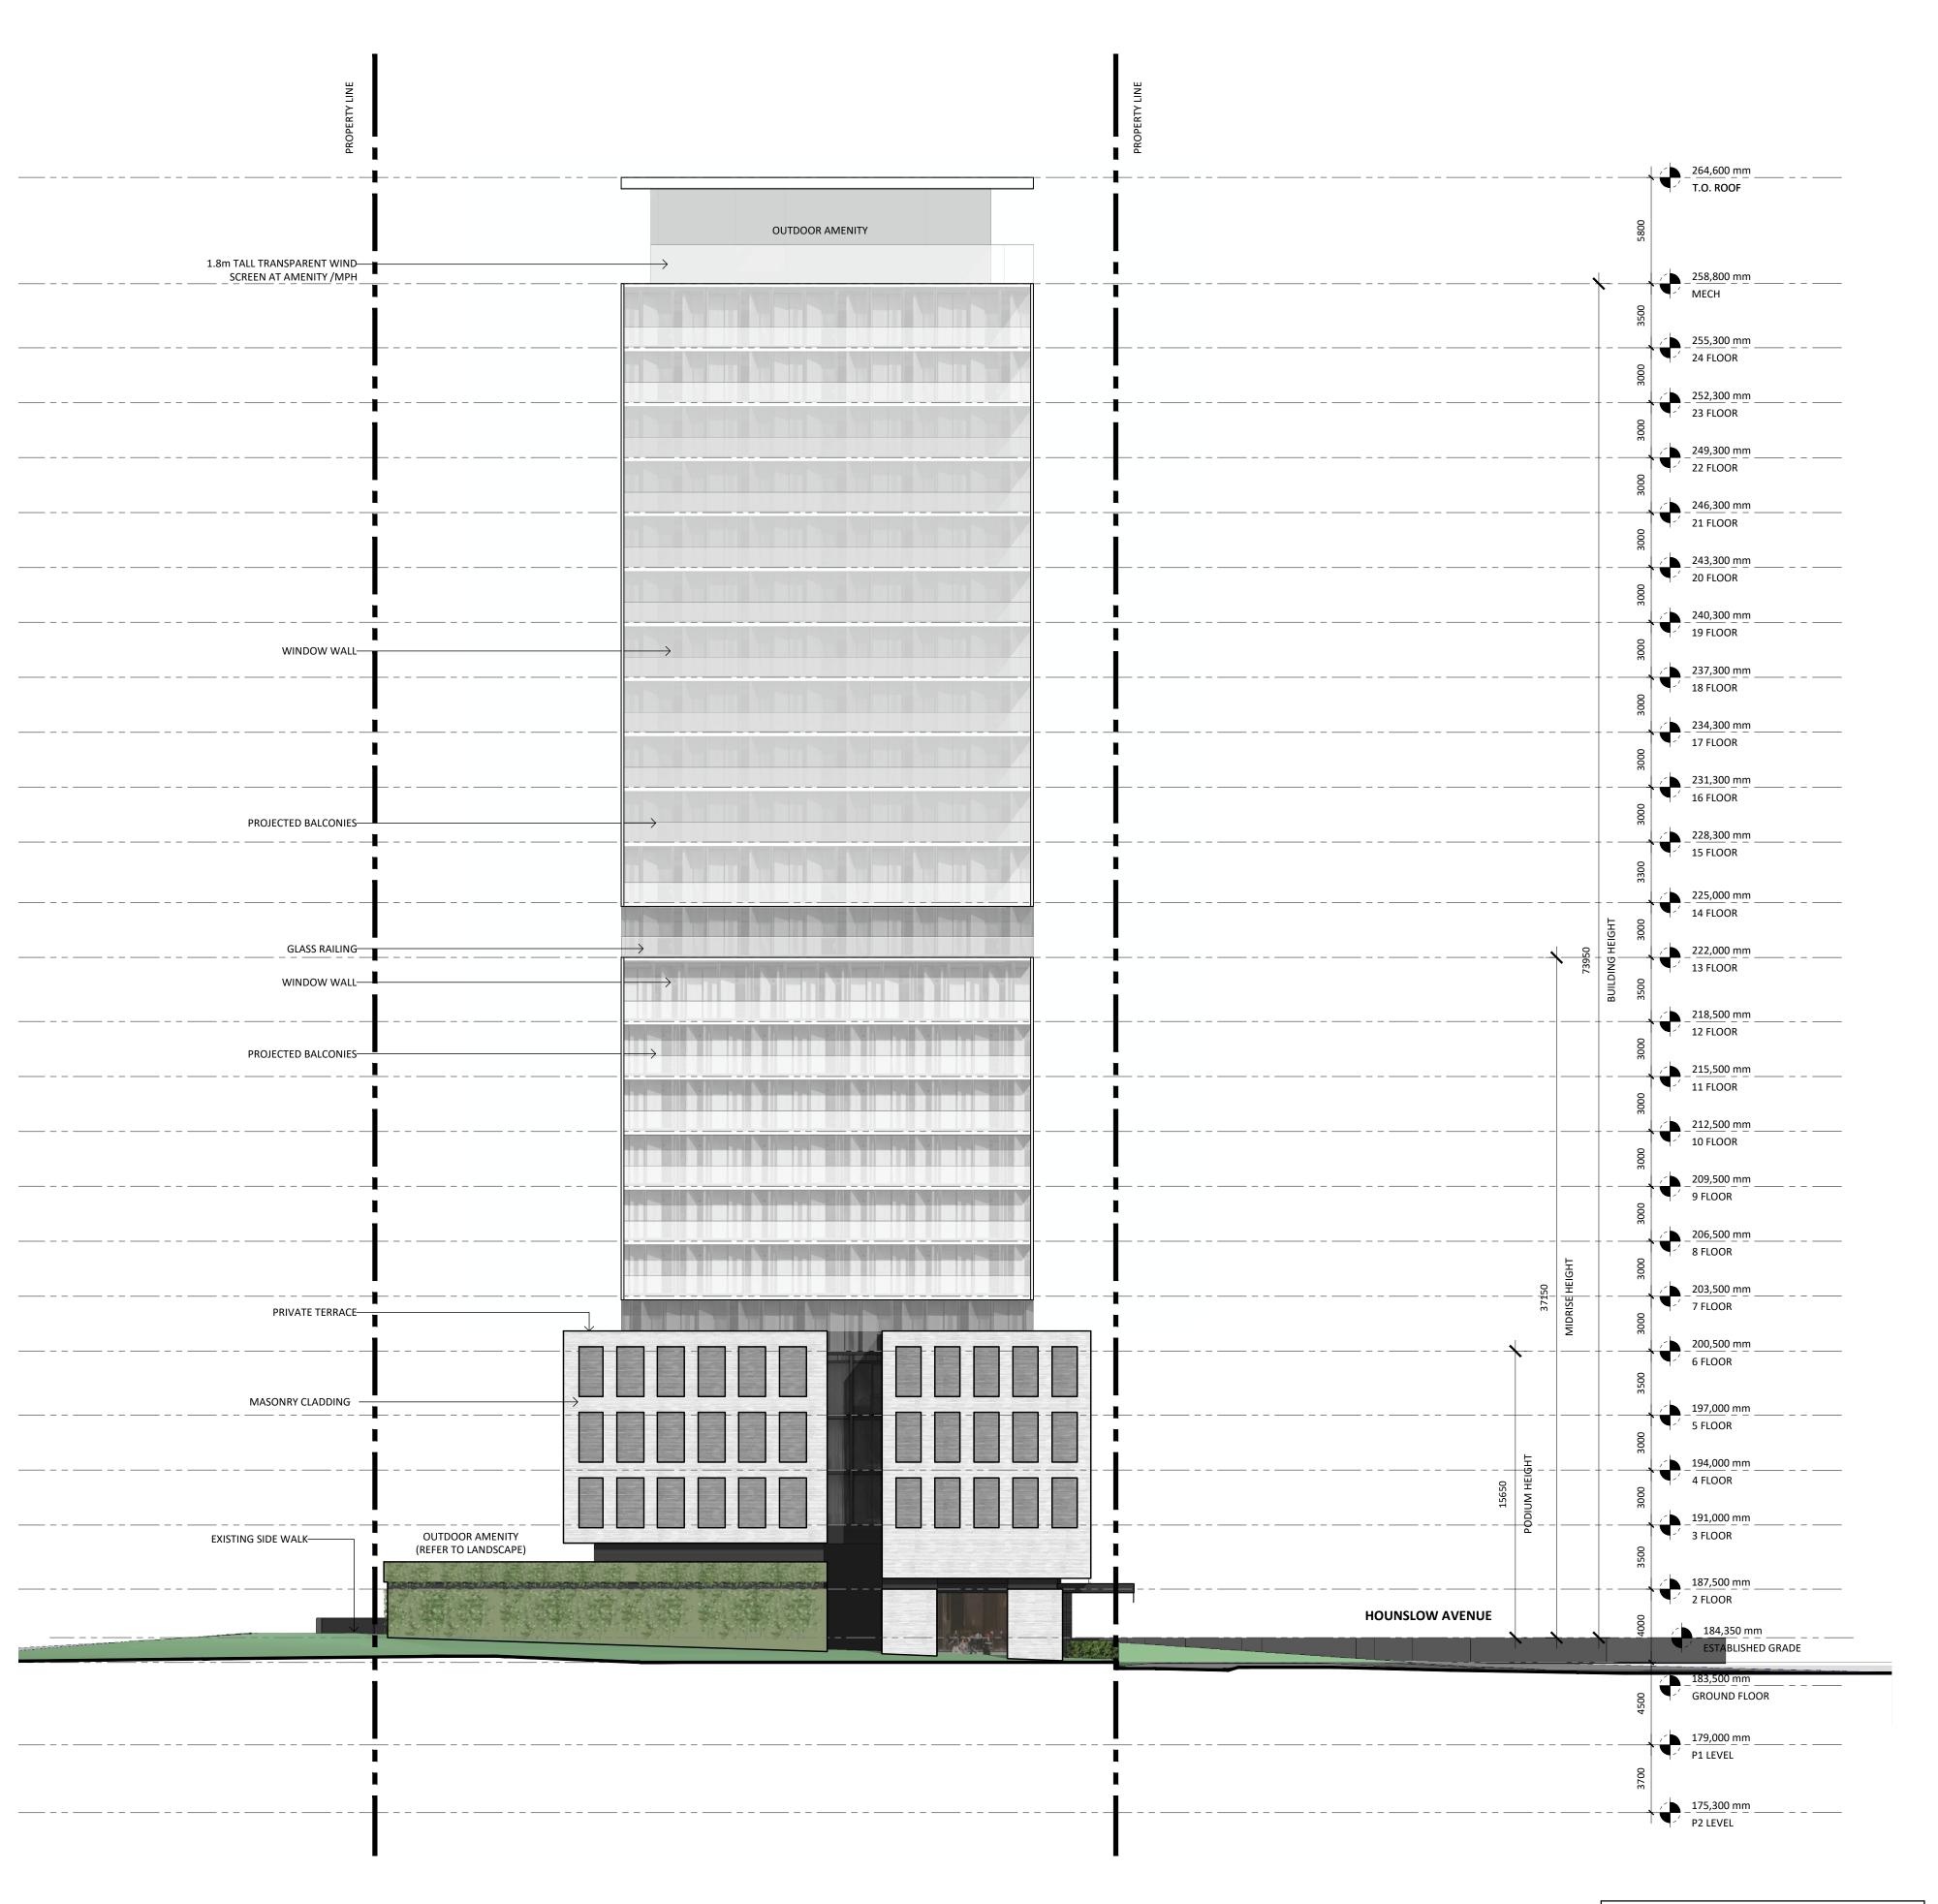
NORTH ELEVATION

Project No.: 2224
Scale: 1:200
Date: SEPTEMBER 29, 2023

Drawn by: STUDIO JCI

Drawing No.:

A 5.02



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PROPOSED RESIDENTIAL DEVELOPMENT

WEST ELEVATION


Drawn by: STUDIO JCI

ADDRESS:

26-28 Hounslow Ave, North York, ON M2N 2A8

A 5.03

SEPTEMBER 29, 2023

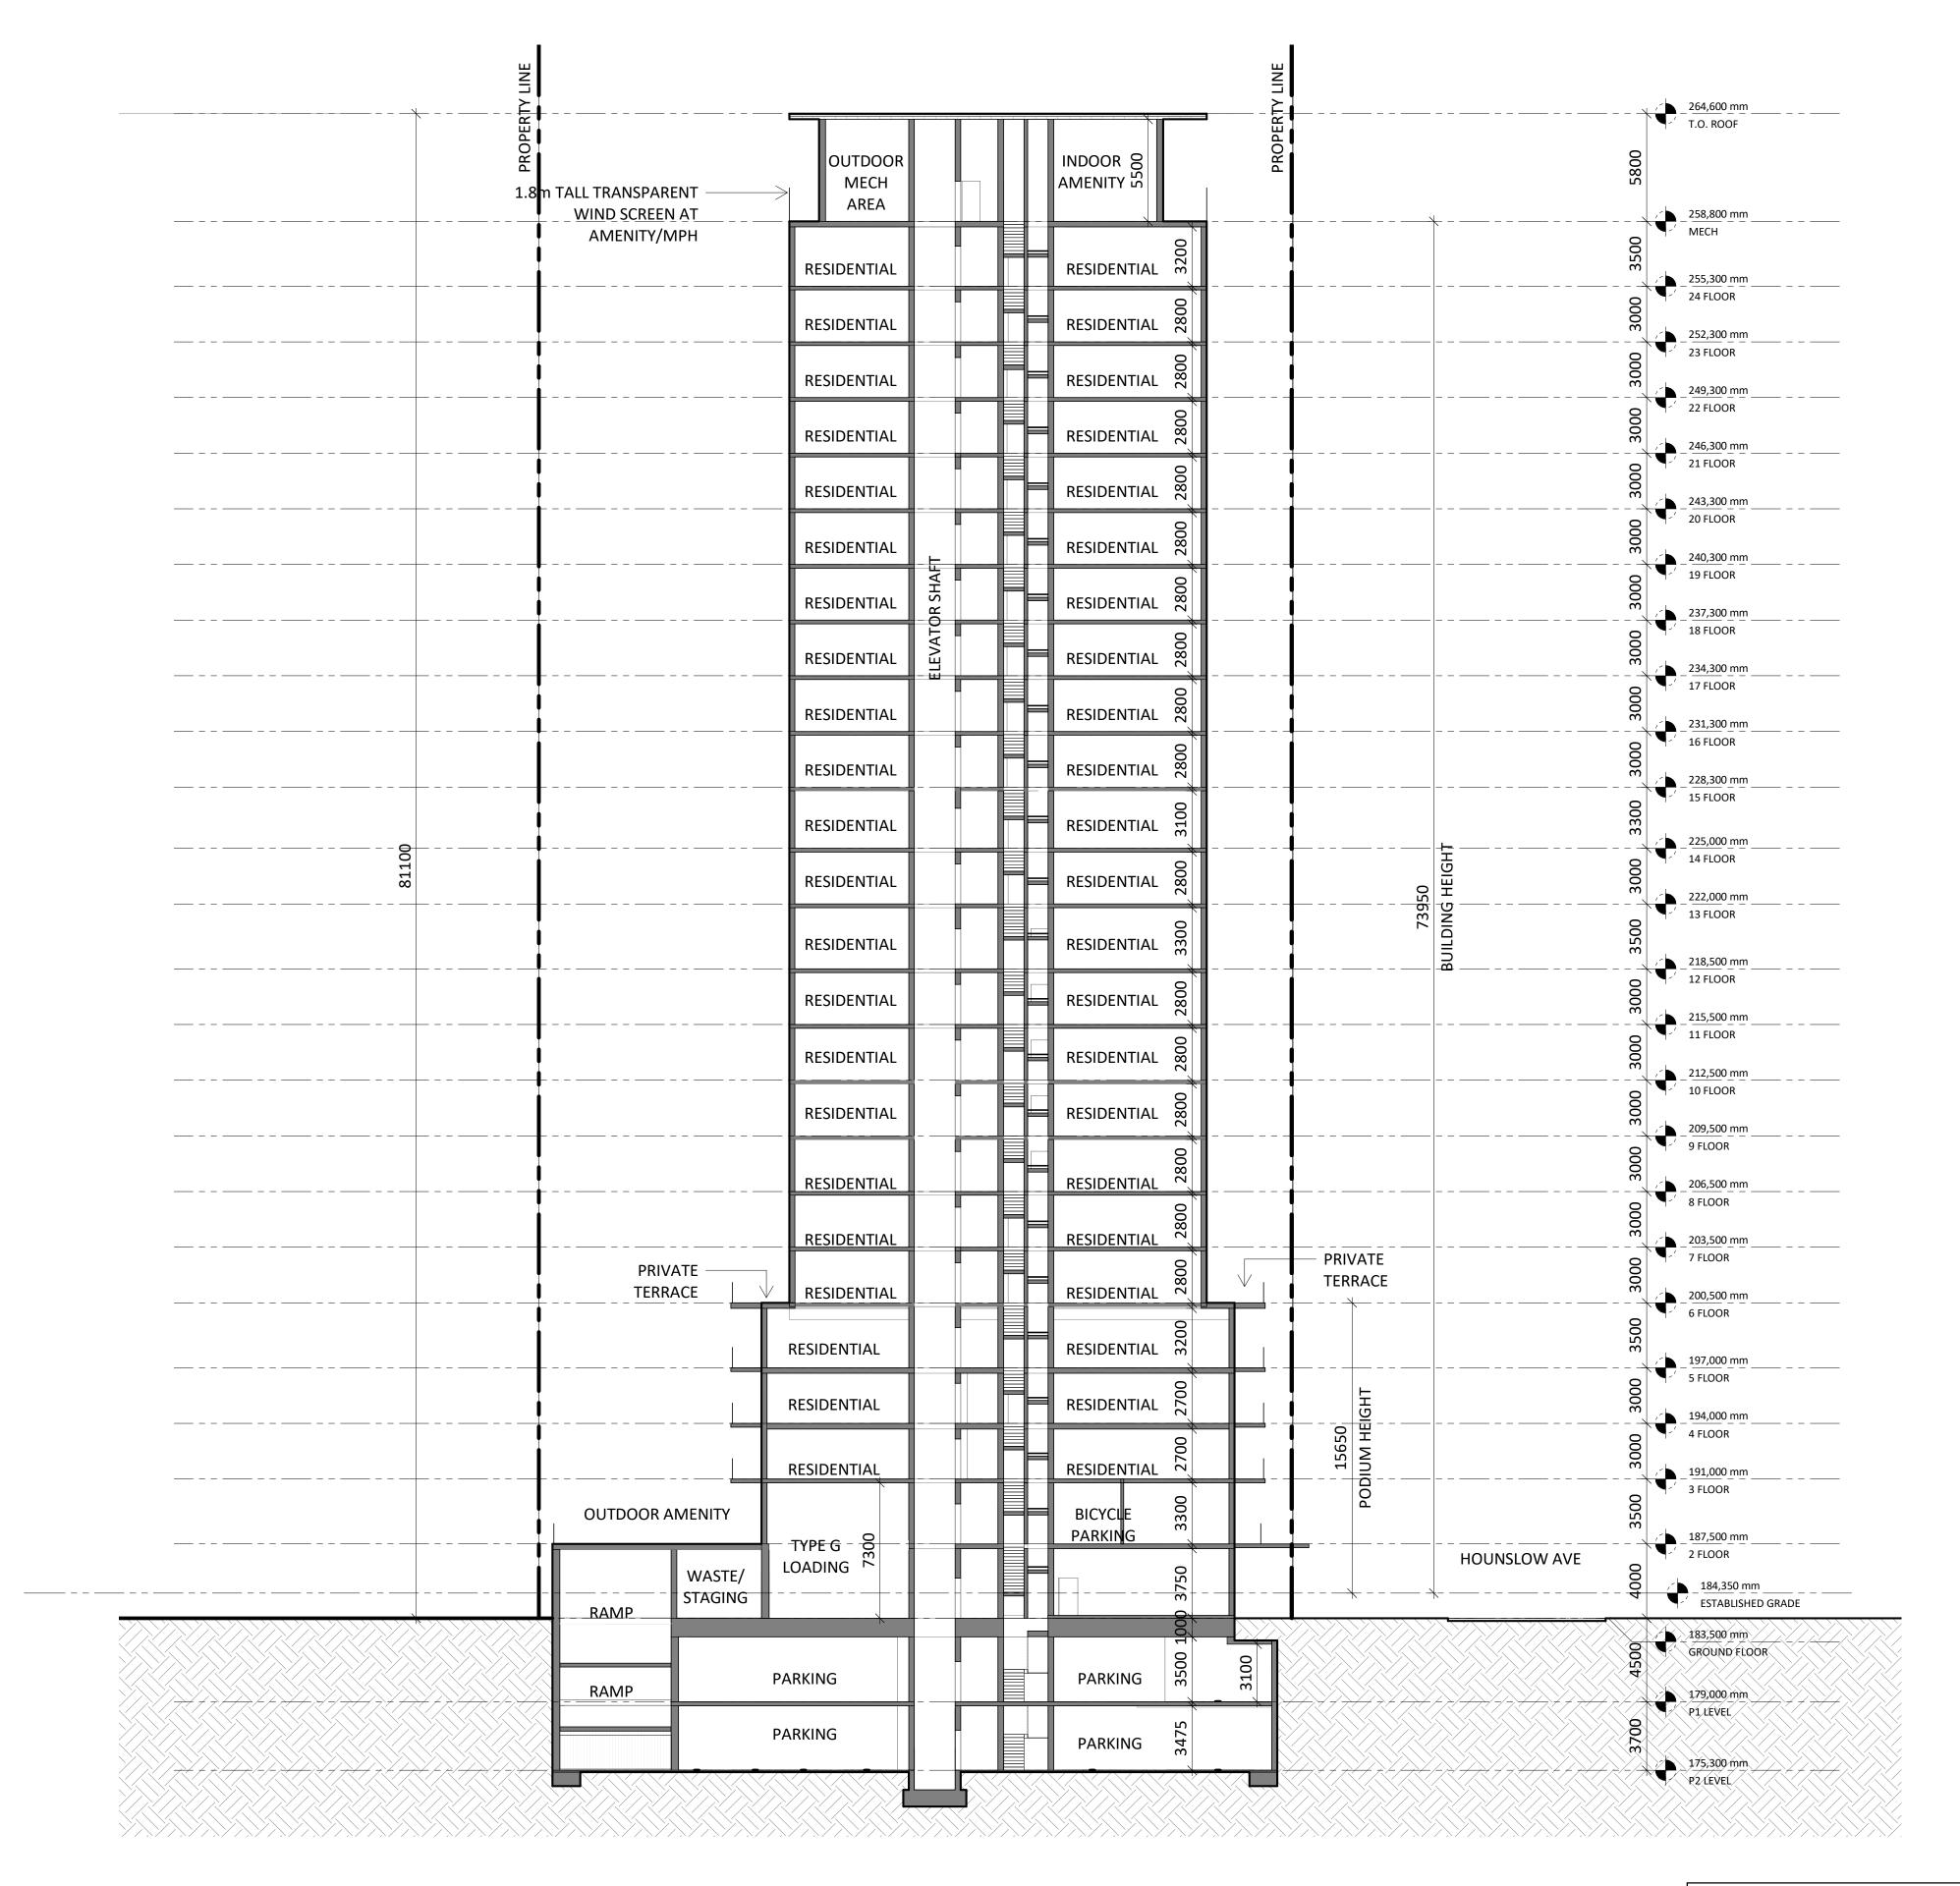

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Issued:

OPA/ZBA

1. These Contract Documents are the

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design conformance only.

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PROPOSED RESIDENTIAL DEVELOPMENT

1:200

ADDRESS:

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SECTION A

Project No.: 2224

Drawn by: STUDIO JCI

Scale:

Architect will provide written/graphic clarification or supplementary information regarding the intent of the Contract

2. Drawings are not to be scaled for

3. Positions of exposed or finished


Rev. Issuance

General Notes:

Sep. 29, 2023

A 6.00

SEPTEMBER 29, 2023

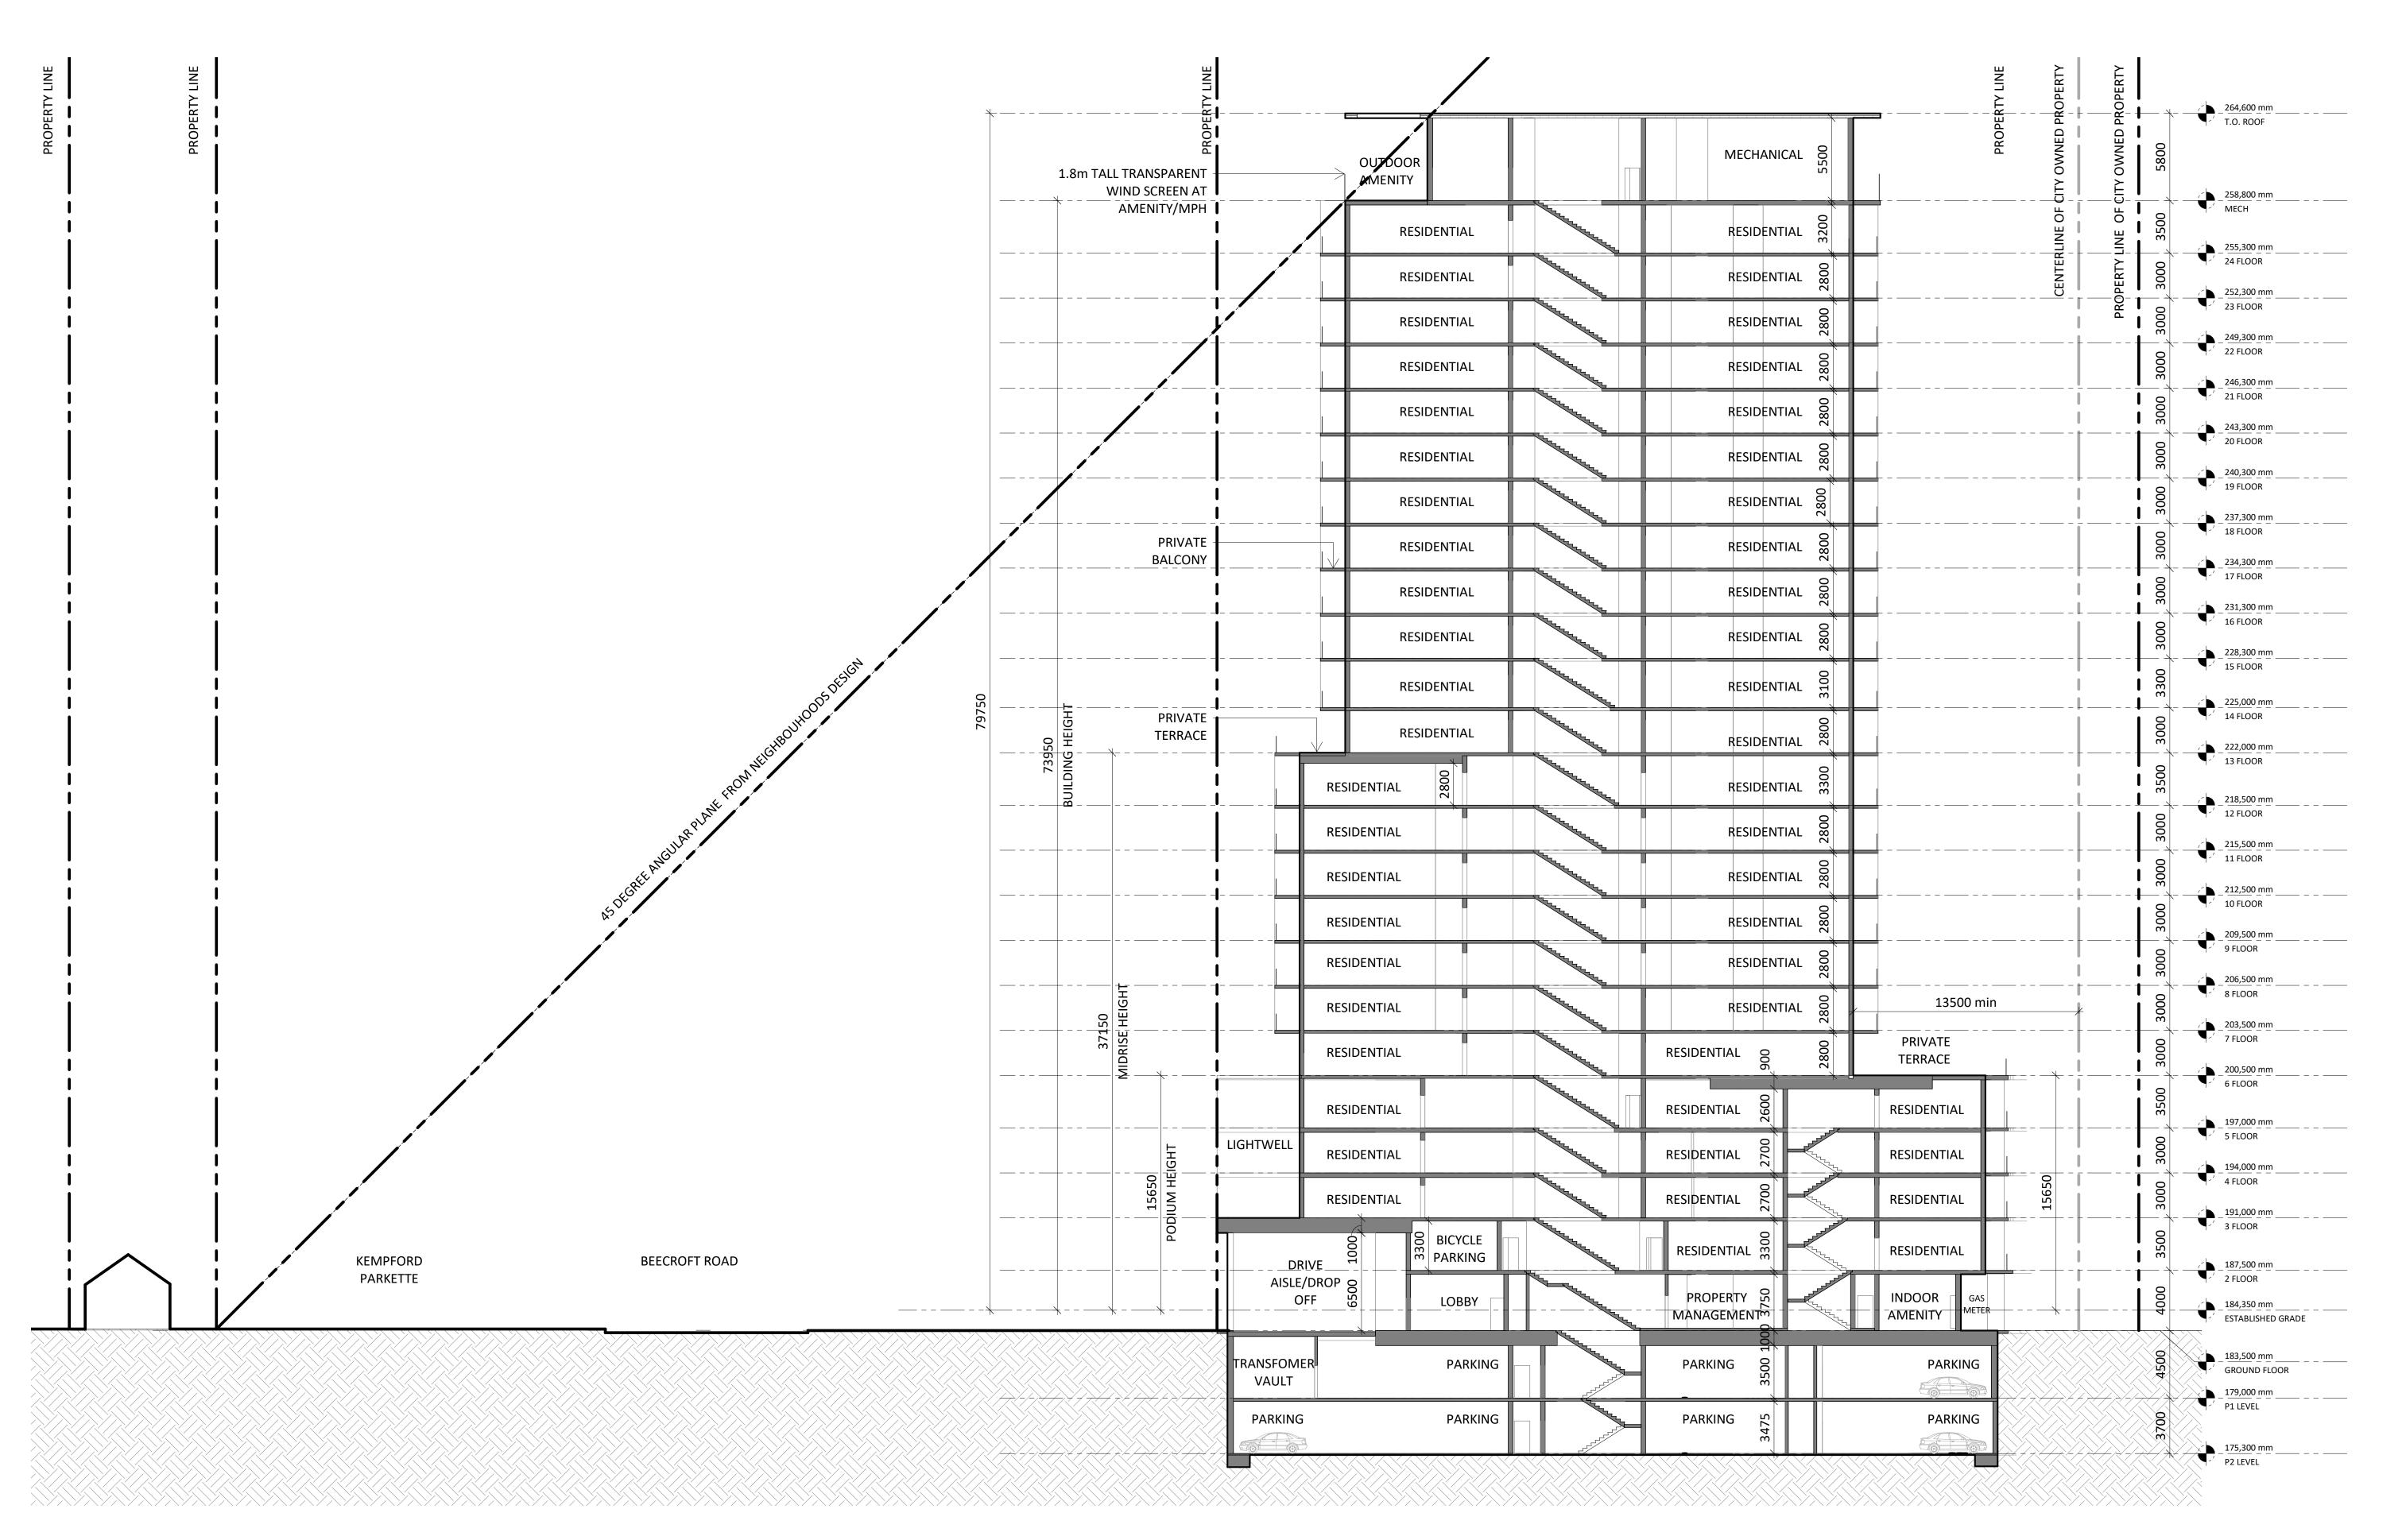

(HOUNSLOW) AT PROPERTY LINE.

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Issued:

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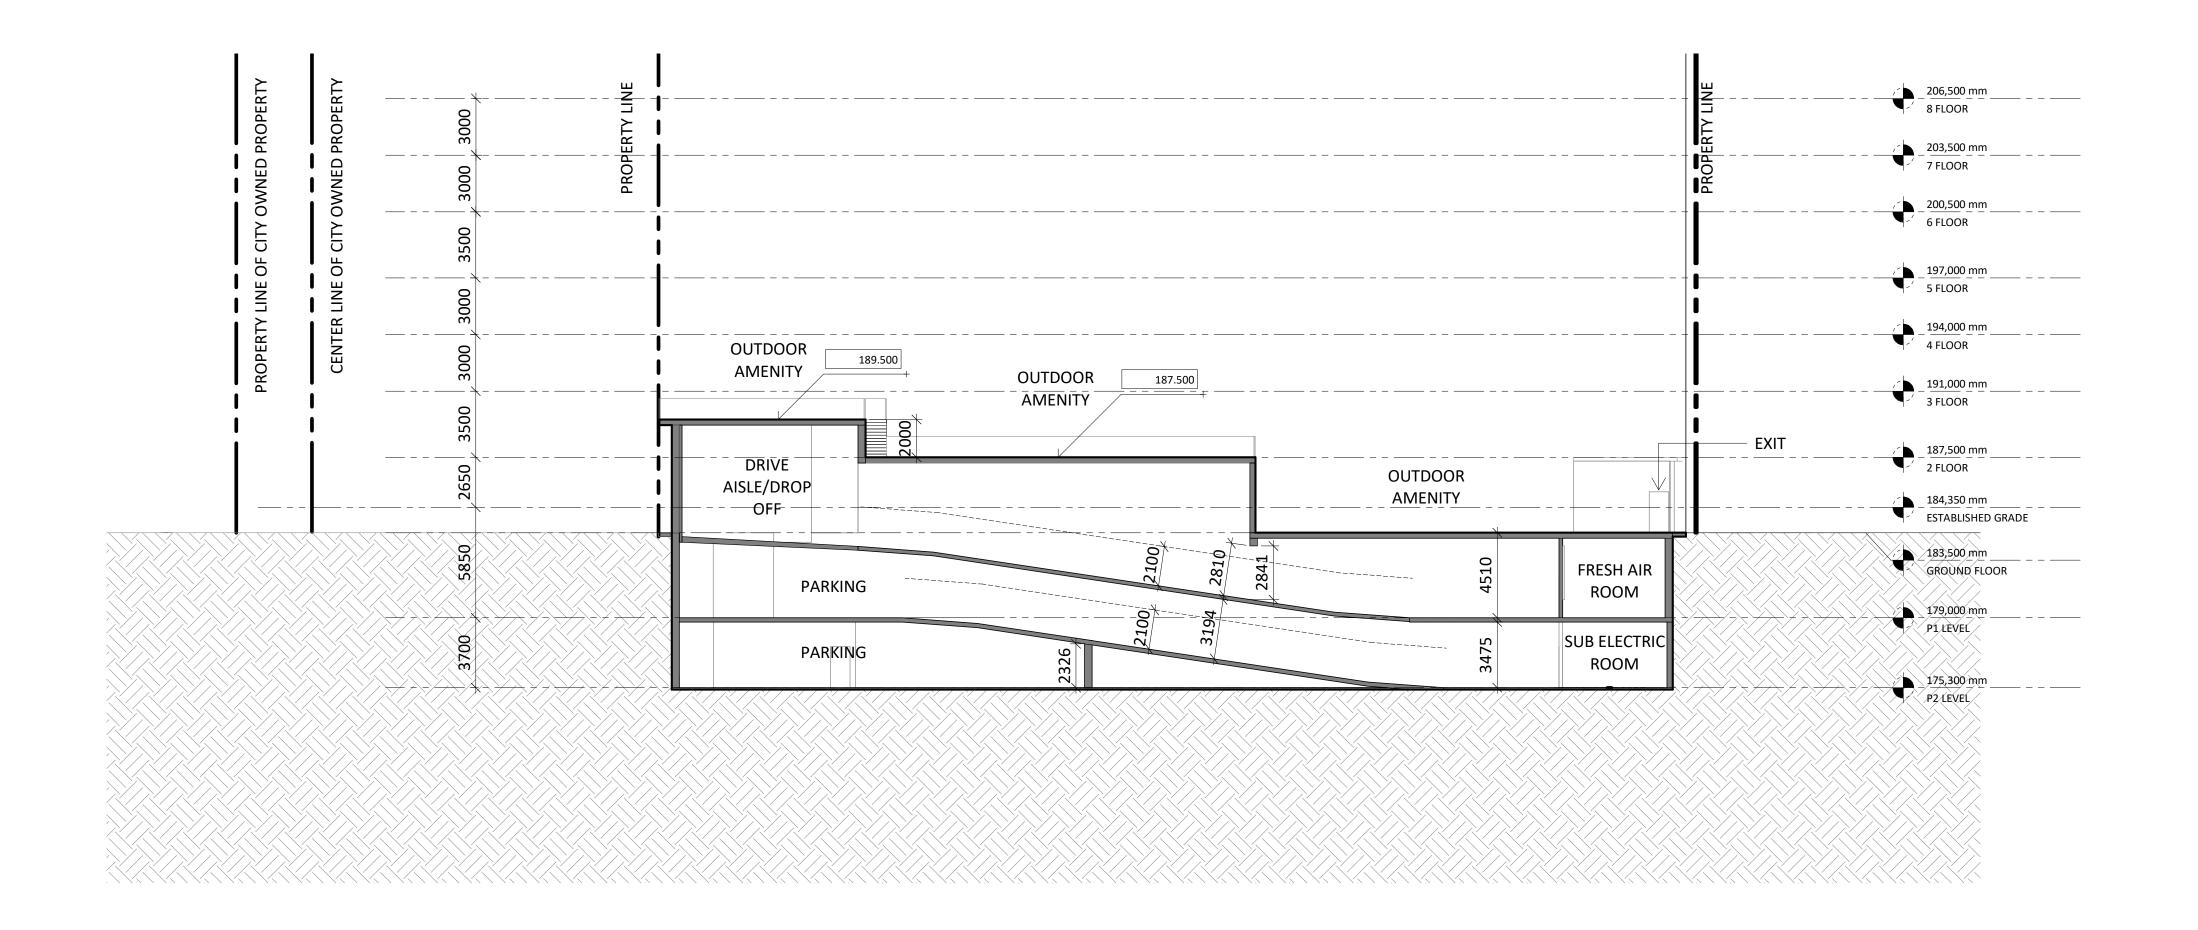
SECTION 1

Project No.: 2224 Scale: 1:200

Scale: 1 : 200
Date: SEPTEMBER 29, 2023
Drawn by: STUDIO JCI

Prawing No.:

A 6.01



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ADDRESS: 26-38 Hounslow Ave, North York, ON M2N 2A8

SECTION 2

Project No.: 2224
Scale: 1:200
Date: SEPTEMBER 29, 2023
Drawn by: STUDIO JCI

Drawing No.:

A 6.02